


STATE OF ALASKA DEPARTMENT OF TRANSPORTATION AND PUBLIC FACILITIES SITKA SEAWALK PHASE II

AKDOT&PF PROJECT NO. SFHWY00312/AK SIT 2017(1)

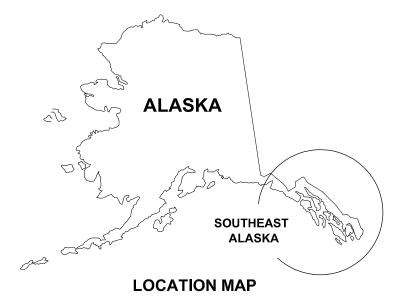

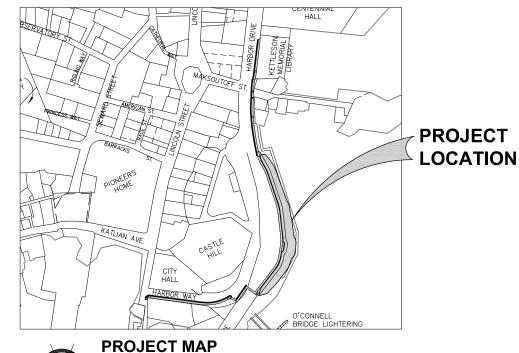

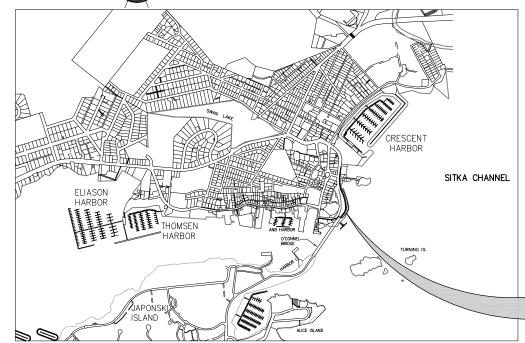



DWG. NO. **GENERAL** TITLE SHEET, VICINITY MAP AND DRAWING INDEX GENERAL NOTES, LEGEND AND ABBREVIATIONS G2 SURVEY CONTROL AND SHEET LAYOUT G3 G4 SECTION 1 EXISTING CONDITIONS PLAN SECTION 2 EXISTING CONDITIONS PLAN SECTION 3 EXISTING CONDITIONS PLAN G6 CIVIL C1 TYPICAL SECTIONS C2 OVERALL SITE PLAN SECTION 1 SITE PLAN SECTION 2 EAST SITE PLAN SECTION 2 WEST SITE PLAN C5 C6 SECTION 3 SITE PLAN LANDSCAPE OVERALL LANDSCAPE PLAN SECTION 1 LANDSCAPE PLAN SECTION 2A LANDSCAPE PLAN SECTION 2B LANDSCAPE PLAN SECTION 3 LANDSCAPE PLAN L5 LANDSCAPE DETAILS L7 LANDSCAPE DETAILS **ELECTRICAL** SECTION 1 SITE PLAN - ELECTRICAL SECTION 2 SITE PLAN - ELECTRICAL E2 LIGHT POLE DETAILS TRENCH DETAIL E4 LIGHTING LOAD CENTER DETAILS E5

DRAWING INDEX

VICINITY MAP

PLANS DEVELOPED BY PND ENGINEERS INC. CERTIFICATE OF AUTHORIZATION NO. AECC250 9360 GLACIER HWY. JUNEAU, AK. 99801

REVISIONS REV. DATE DWN. CKD. APF DESIGN: TCB CHECKED: TCB

PROJECT LOCATION

APPROVED:

PRELIMINARY DESIGN

STATE OF ALASKA DEPARTMENT OF TRANSPORTATION AND PUBLIC FACILITIES SITKA SEAWALK PHASE II AKDOT&PF PROJECT NO. SFHWY00312

TITLE SHEET, VICINITY MAP AND DRAWING INDEX

PND PROJECT #: 222064 | C.A.N. #: AECC250

G1

PND ENGINEERS, INC. (PND) IS NOT RESPONSIBLE FOR SAFETY PROGRAMS, METHODS OR PROCEDURES OF OPERATION, OR THE CONSTRUCTION OF THE DESIGN SHOWN ON THESE DRAWINGS. DRAWINGS ARE FOR THE USE OF THIS PROJECT ONLY AND ARE NOT INTENDED FOR REUSE WITHOUT WRITTEN APPROVAL FROM PND. DRAWINGS ARE ALSO NOT TO BE USED IN ANY MANNER THAT WOULD CONSTITUTE A DETRIMENT DIRECTLY OR INDIRECTLY TO PND.

SOUTHEAST **ALASKA**


GENERAL NOTES

NO ADDITIONAL COST TO THE OWNER.

- 1. AKDOT STANDARD SPECIFICATIONS FOR HIGHWAY CONSTRUCTION ARE MADE PART OF THIS CONTRACT, DETAILS NOT SHOWN SHALL CONFORM THERETO w/ MODIFICATIONS SPECIFIED.
- 2. PROPERTY DISTURBED DURING CONSTRUCTION SHALL BE RESTORED TO ITS PRE-CONSTRUCTION CONDITION OR BETTER AT
- 3. PROPERTY LINE LOCATIONS USED IN THESE PLANS ARE DERIVED FROM RECORD PLATS AND DO NOT REPRESENT A BOUNDARY SURVEY.
- 4. THE LOCATIONS AND ELEVATIONS OF EXISTING FEATURES AND UTILITIES SHOWN ON THE DRAWINGS ARE APPROXIMATE. UTILITIES SHOWN ARE TAKEN FROM EXISTING RECORDS AND OTHER SOURCES. ADDITIONAL UTILITIES MAY BE PRESENT HOWEVER ARE NOT SHOWN. THE CONTRACTOR SHALL VERIFY ALL UTILITY LOCATIONS IN THE FIELD SA NECESSARY PRIOR TO BEGINNING WORK. THE HORIZONTAL AND VERTICAL LOCATIONS OF ALL UTILITIES ENCOUNTERED IN THE FIELD SHALL BE RECORDED ON THE CONTRACTOR'S RECORD DRAWINGS. CONTACT LOCAL UTILITIES AT THE FOLLOWING NUMBERS FOR LOCATE SERVICE A MINIMUM OF TWO BUSINESS DAYS PRIOR TO ANY EXCAVATION:

CABLE: GCI 811
WATER AND SEWER: CBS ENVIRONMENTAL DIVISION 747-4060
ELECTRIC: CBS ELECTRIC DEPARTMENT 747-1884

- 5. PROTECT ALL EXISTING UTILITIES DURING CONSTRUCTION. NO ASSURANCE IS GIVEN THAT THE INDICATED POSITION OF ANY EXISTING UTILITY IS CORRECT OR THAT THE INFORMATION IS COMPLETE. ALL LOCATIONS OF EXISTING UTILITIES ARE APPROXIMATE AND IT SHALL BE THE CONTRACTOR'S RESPONSIBILITY TO VERIFY THE CORRECT AND TRUE LOCATION AS TO AVOID DAMAGE OR DISTURBANCE. DAMAGE TO EXISTING SITE FACILITIES SHALL BE REPAIRED BY THE CONTRACTOR AT NO COST TO THE OWNER.
- 6. OVERHEAD UTILITIES INCLUDING ELECTRICAL POWER, TELEPHONE, CABLE TV, AND OTHER OVERHEAD LINES ARE GENERALLY NOT SHOWN, THE LINES THAT ARE SHOWN ARE LOCATED BY POINT—TO—POINT, POLE—TO—POLE. DETERMINE THE EXTENT OF HAZARDS OR IMPACTS ON CONSTRUCTION ACTIVITIES CREATED BY OVERHEAD OR UNDERGROUND LINES IN ALL AREAS AND FOLLOW PROCEDURES DURING CONSTRUCTION AS REQUIRED BY LAW. PRIOR TO CONSTRUCTION, MEET WITH UTILITY OWNERS TO DETERMINE THE EXTENT OF HAZARDS AND TAKE PRECAUTIONS AS REQUIRED TO PROTECT PERSONS AND PROPERTY AND TO AVOID DISRUPTION OF SERVICE.
- CONTRACTOR SHALL COORDINATE WITH ALASKA PACIFIC ENVIRONMENTAL SERVICES (747-5669) TO ENSURE
 GARBAGE PICKUP, AND SHALL ENSURE DAILY MAIL SERVICE WILL BE UNINTERRUPTED TO ALL BUSINESSES
 AND RESIDENCES AFFECTED BY THE PROJECT.
- 8. THE CONTRACTOR SHALL NOTIFY CBS PUBLIC WORKS AND ALL AFFECTED RESIDENTS OF PROPOSED UTILITY SERVICE INTERRUPTIONS AT LEAST 72 HOURS PRIOR TO WORK.
- 9. GRADING AND ALIGNMENT OF PIPE, STRUCTURES & FINAL SURFACING ARE SUBJECT TO MINOR REVISIONS BY THE ENGINEER TO FIT SITE CONDITIONS. GRADE ALL IMPROVEMENTS WITH POSITIVE DRAINAGE AWAY FROM BUILDINGS TO DITCHES, SWALES OR STORM DRAIN INLETS, (INCIDENTAL).
- 10. THE DRAWINGS DO NOT NECESSARILY SHOW ALL TREES, BUSHES OR OTHER PLANTINGS THAT WILL BE ENCOUNTERED DURING CONSTRUCTION ACTIVITIES. NO TREES, BUSHES OR OTHER PLANTING SHALL BE DAMAGED OR REMOVED EXCEPT AS SHOWN OR APPROVED BY THE ENGINEER.
- 11. ALL ITEMS DESIGNATED TO BE REMOVED, INCLUDING PAVEMENT, SHALL BE DISPOSED OF AT CONTRACTOR—PROVIDED DISPOSAL SITE, APPROVED BY THE ENGINEER, EXCEPT AS NOTED.
- 12. CONTRACTOR SHALL REFERENCE ALL EXISTING PROPERTY CORNER MONUMENTS, RIGHT OF WAY MONUMENTS, AND CENTERLINE MONUMENTS PRIOR TO CONSTRUCTION. UNLESS NOTED OTHERWISE, DISTURBED MONUMENTS SHALL BE RESET OR REPLACED SUBSEQUENT TO PAVING EXCEPT WHERE MONUMENT WOULD BE A HAZARD AS DETERMINED BY THE ENGINEER. EXISTING SURVEY MONUMENTS MAY NOT BE SHOWN ON THE DRAWINGS. ALL WORK SHALL BE DONE BY, OR UNDER THE DIRECTION OF, AN ALASKA REGISTERED LAND SURVEYOR.
- 13. THE CONTRACTOR IS RESPONSIBLE FOR ANY AND ALL DAMAGES TO PRIVATE AND PUBLIC PROPERTY ASSOCIATED WITH THE CONSTRUCTION ACTIVITIES, INCLUDING BUT NOT LIMITED TO DAMAGES CAUSED BY COMPACTION EFFORTS.
- 14. THE CONTRACTOR SHALL NOT STORE MATERIALS OR EQUIPMENT, OR OPERATE EQUIPMENT WITH ITS TRACKS OR WHEELS PLACED ON PRIVATE PROPERTY, WITHOUT THE WRITTEN APPROVAL OF THE PROPERTY OWNER.
- 15. SAWCUT AS NECESSARY ACROSS EXISTING SIDEWALKS, DRIVEWAYS AND PARKING AREAS TO PROVIDE A NEAT MATCH LINE. MAINTAIN 1'-6" MINIMUM CUTBACKS ON ACP, UNLESS NOTED OTHERWISE. SIDEWALK, CURB & GUTTER SHALL BE REPLACED TO THE NEAREST EXISTING CONTROL JOINT.
- 16. HORIZONTAL DIMENSIONS ON PLAN AND PROFILE SHEETS TO PIPELINES, MANHOLES, AND OTHER FACILITIES, ARE TO THE CENTERLINES OF THOSE FACILITIES UNLESS SPECIFICALLY NOTED OTHERWISE. PIPELINE LENGTHS ARE MEASURED HORIZONTALLY. (I.E. PLANAR NOT CORRECTED FOR SLOPE)
- 17. MATCH EXISTING GRADES AT PROJECT LIMITS AND WHERE REQUIRED TO MATCH ELEVATIONS AT EXISTING ROADS.

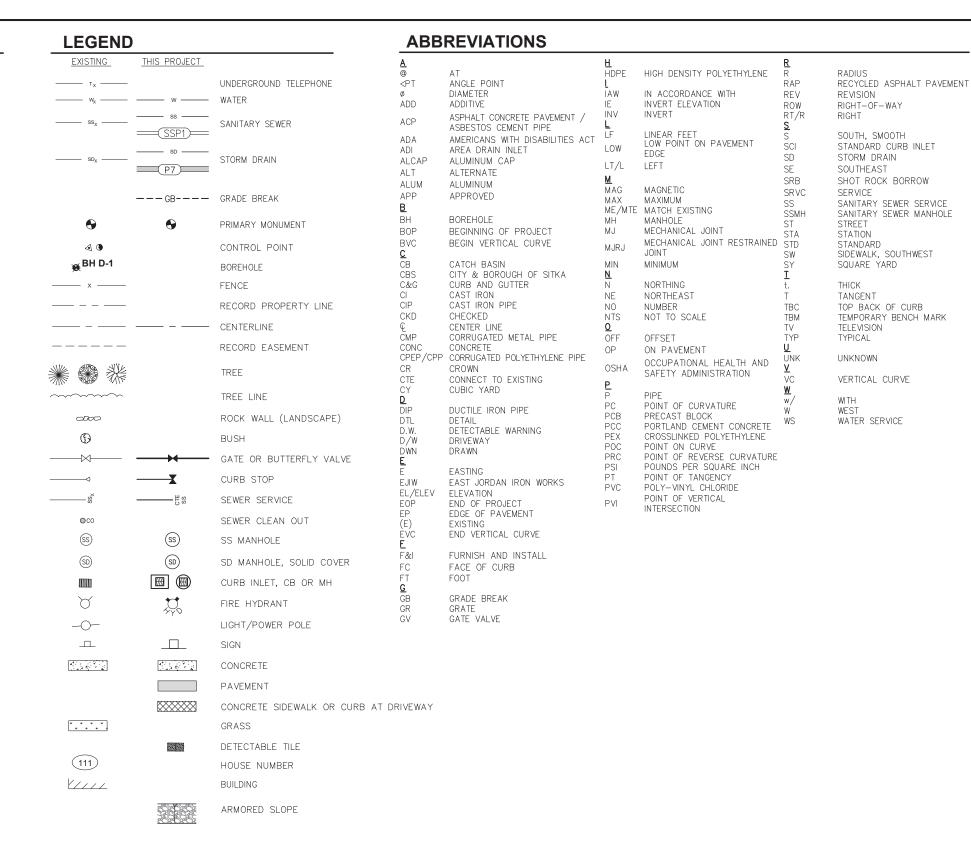

REV. DATE DESCRIPTION DWN. CKD. APP.

DESIGN: TCB CHECKED: TCB

DRAWN: WRB APPROVED:

PRELIMINARY DESIGN


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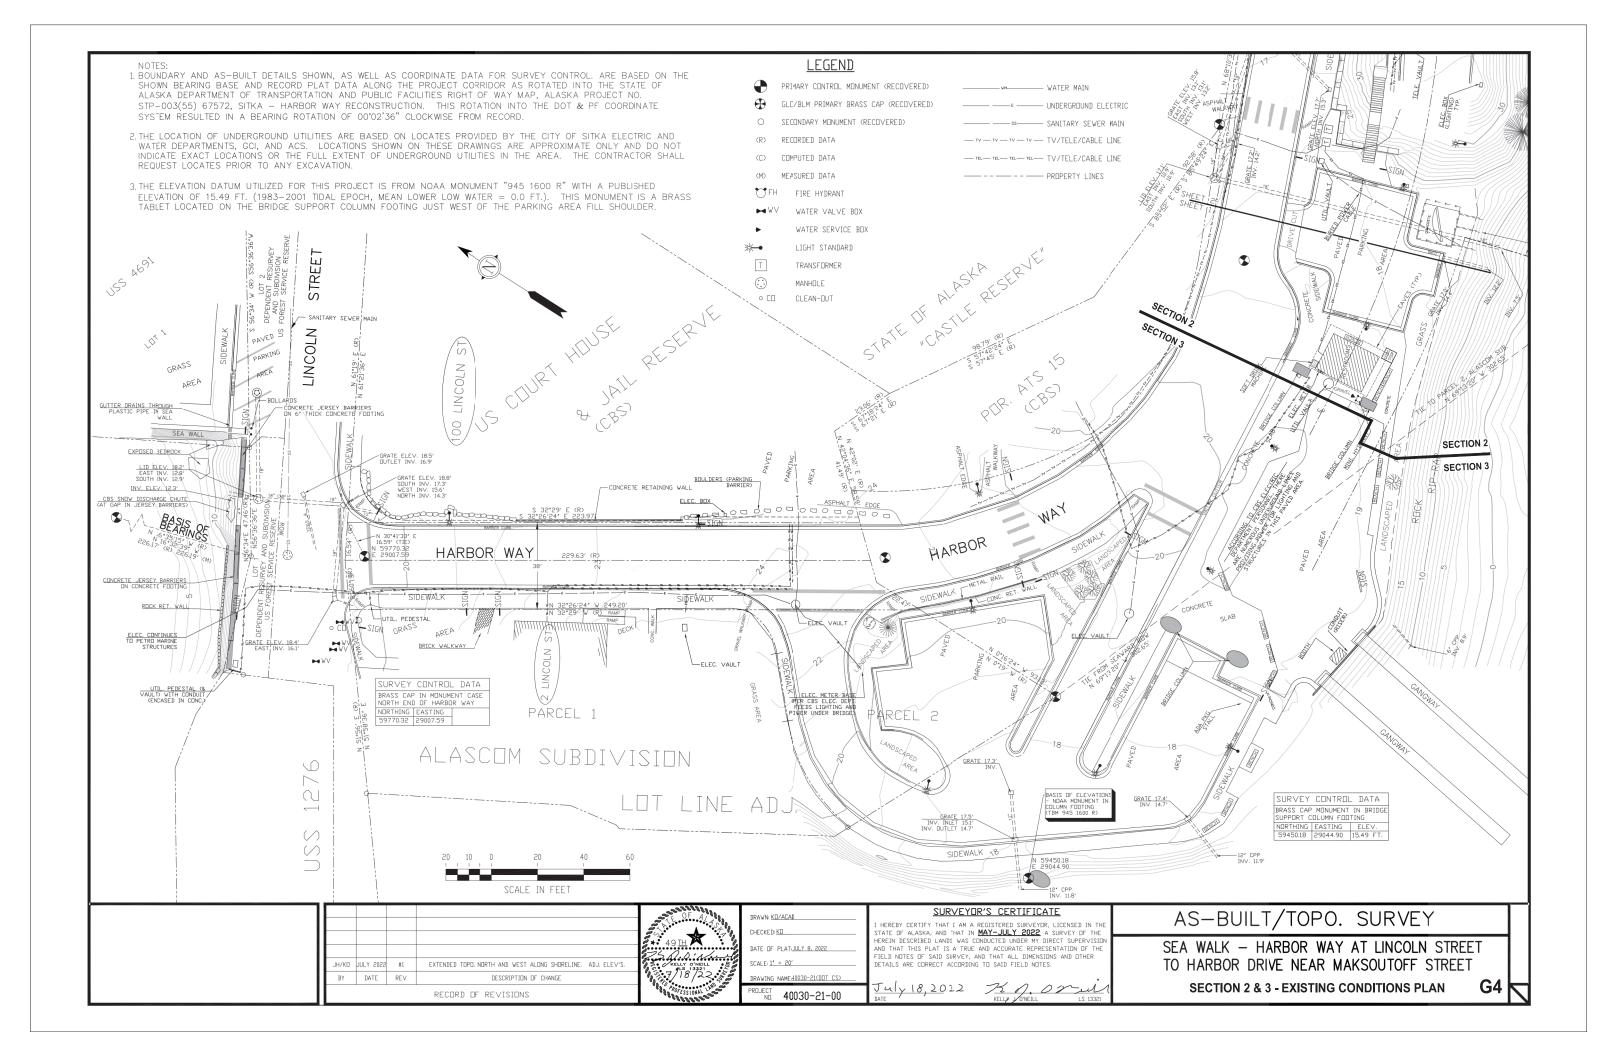
STATE OF ALASKA DEPARTMENT OF TRANSPORTATION AND PUBLIC FACILITIES SITKA SEAWALK PHASE II AKDOT&PF PROJECT NO. SFHWY00312


GENERAL NOTES, LEGEND AND ABBREVIATIONS


PND PROJECT #: 222064 | C.A.N. #: AECC250


G2



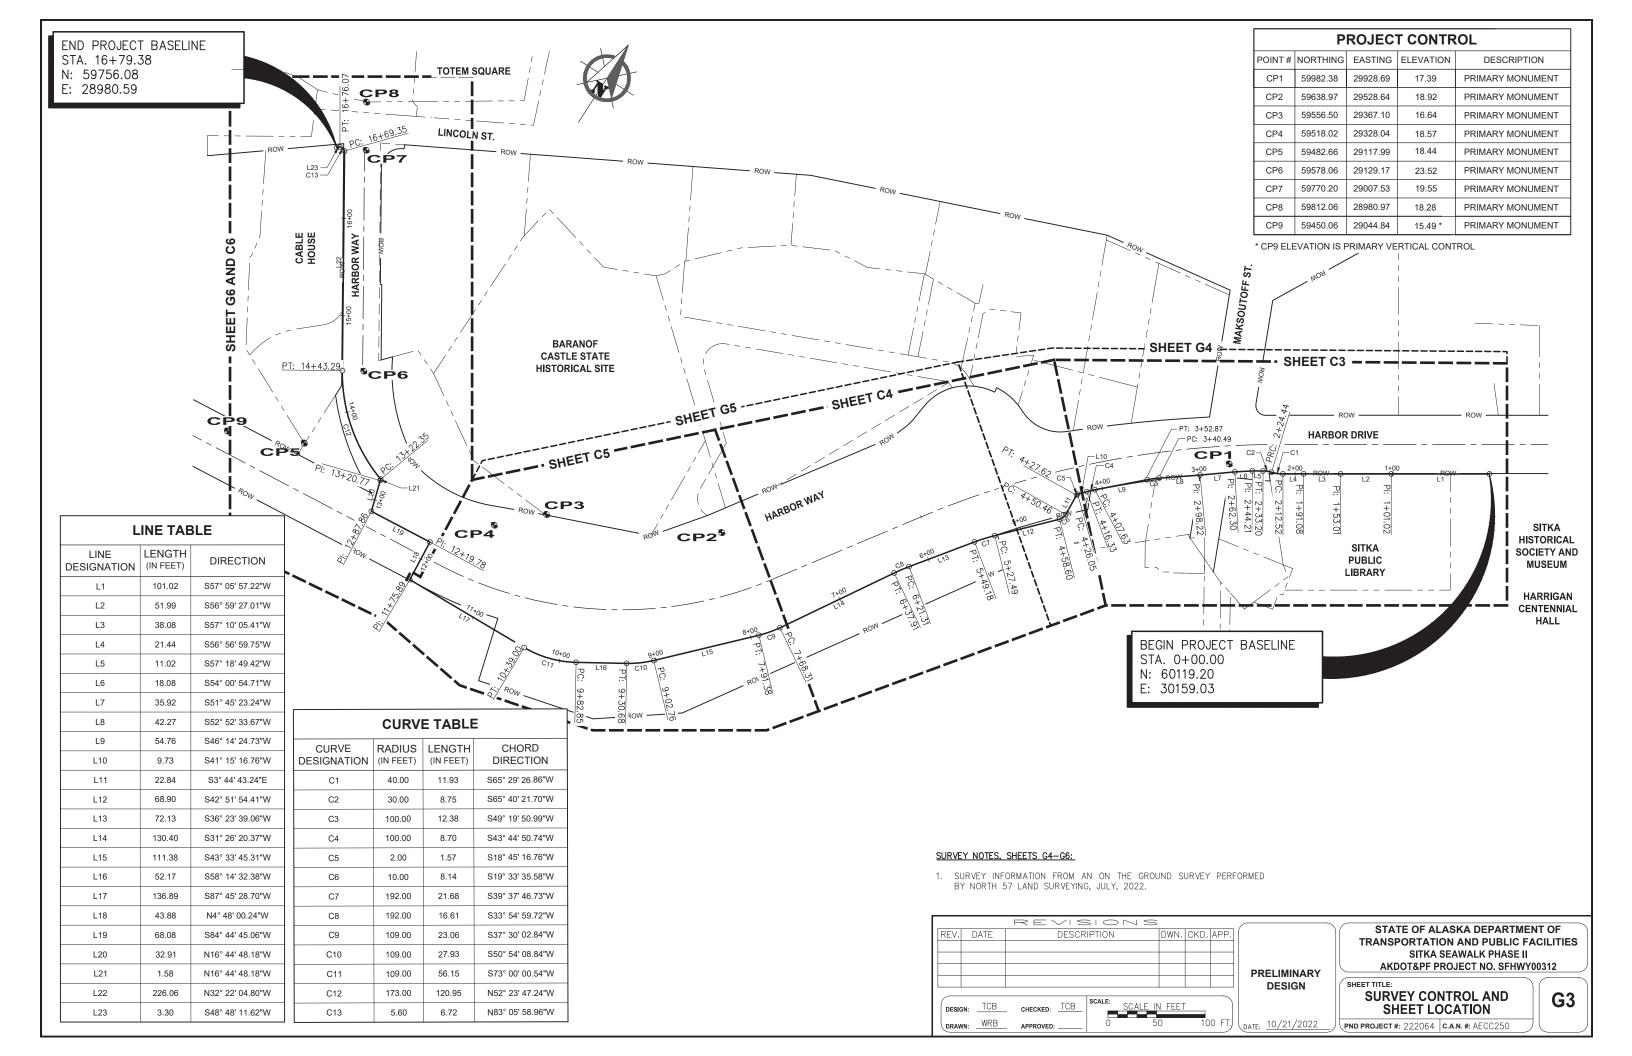

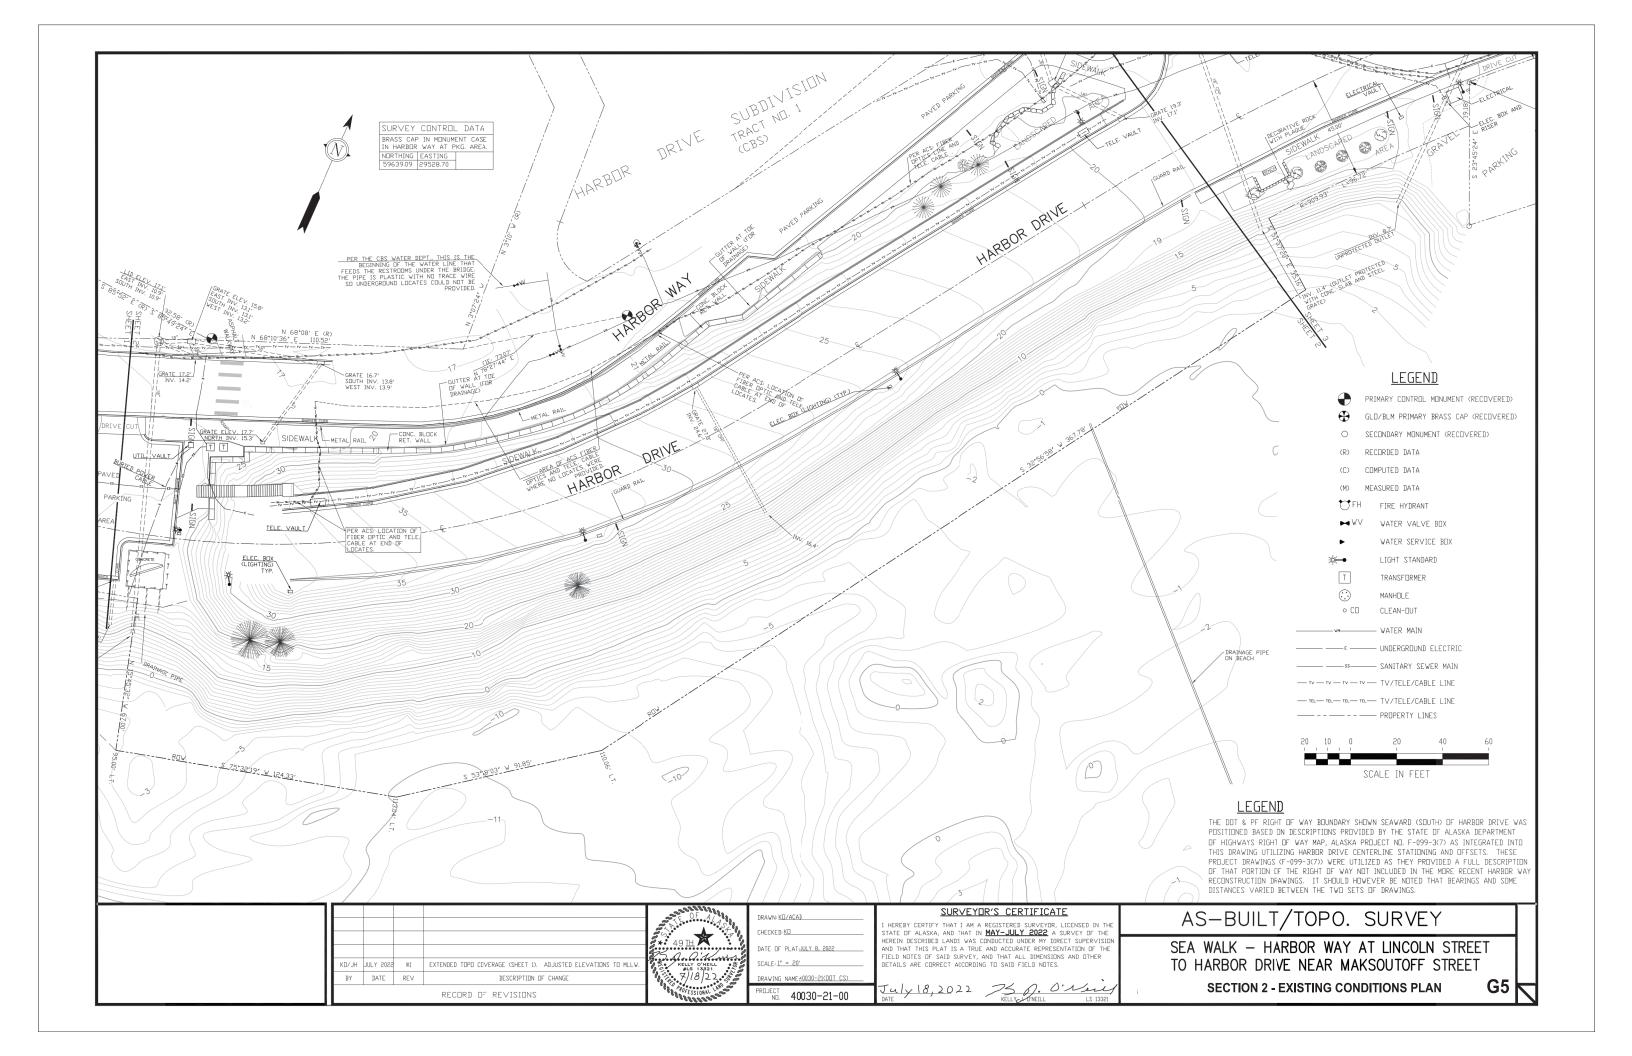

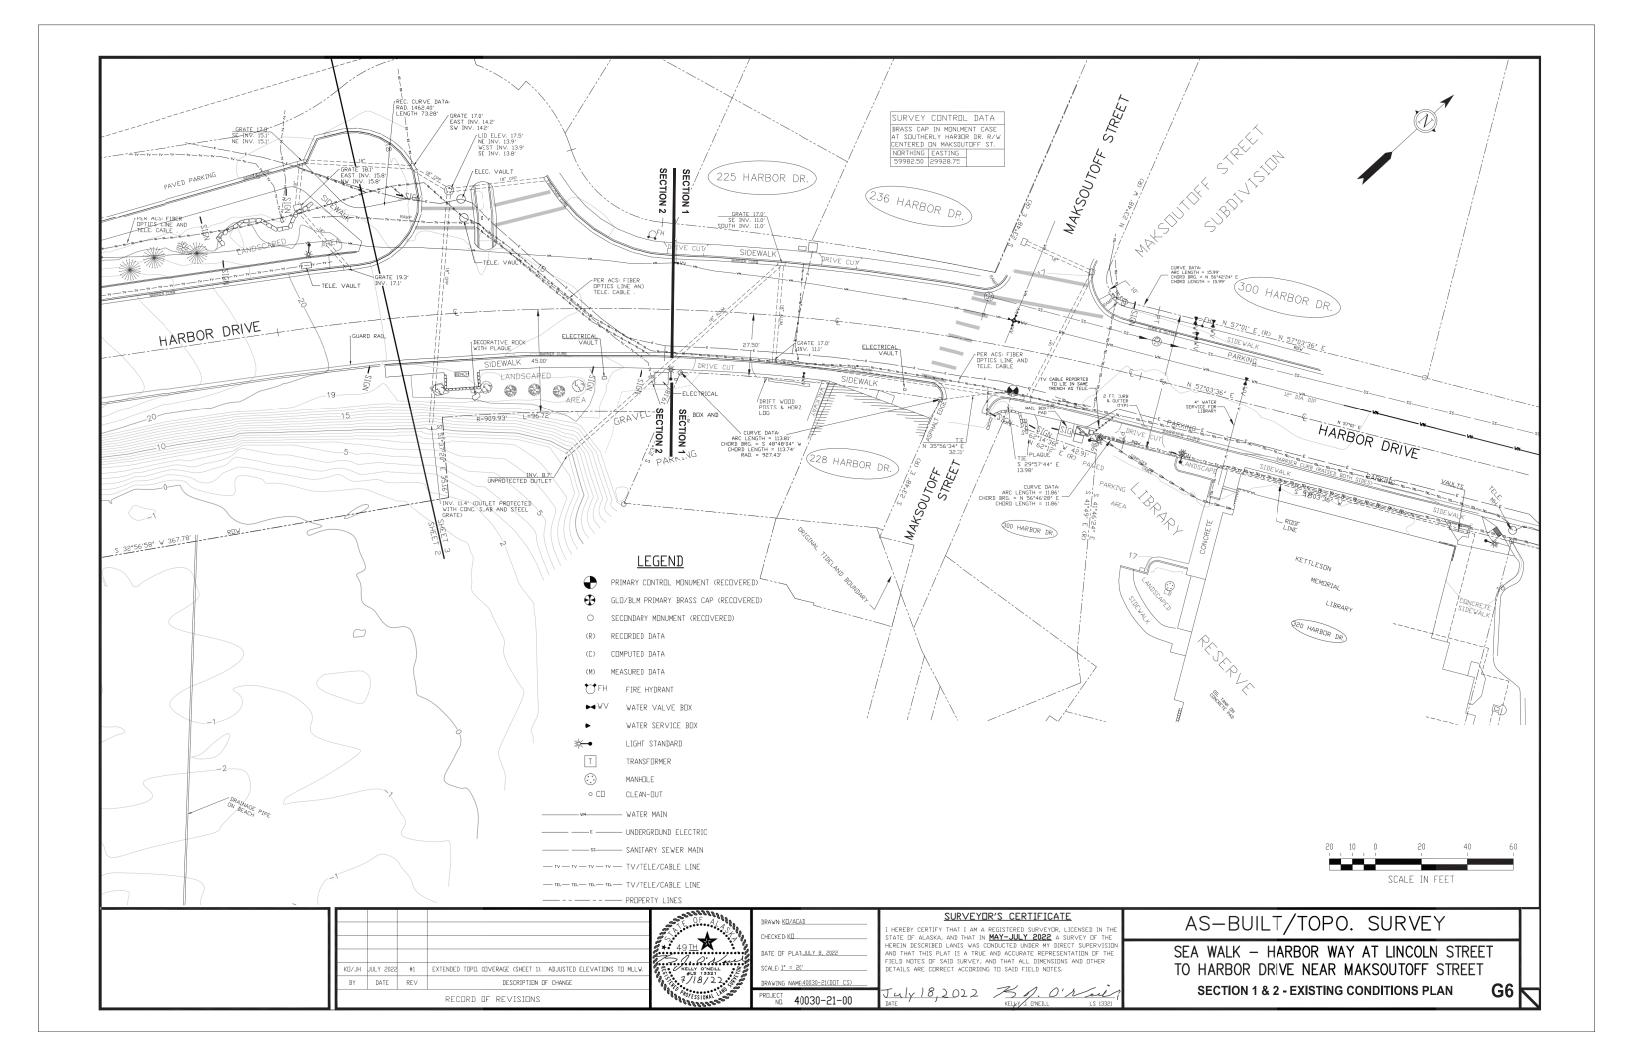


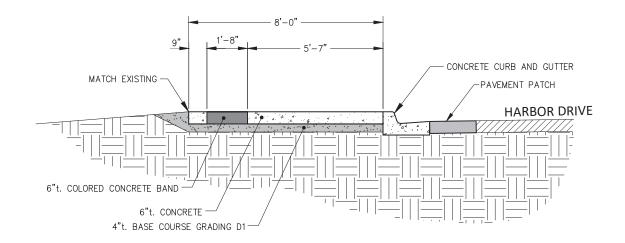

SEAWALK SECTION 1

TYPICAL SECTION


SCALE: 1"=2"

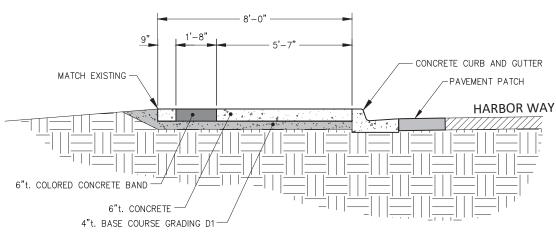




NOTE:

1. CONCRETE SHOWN.

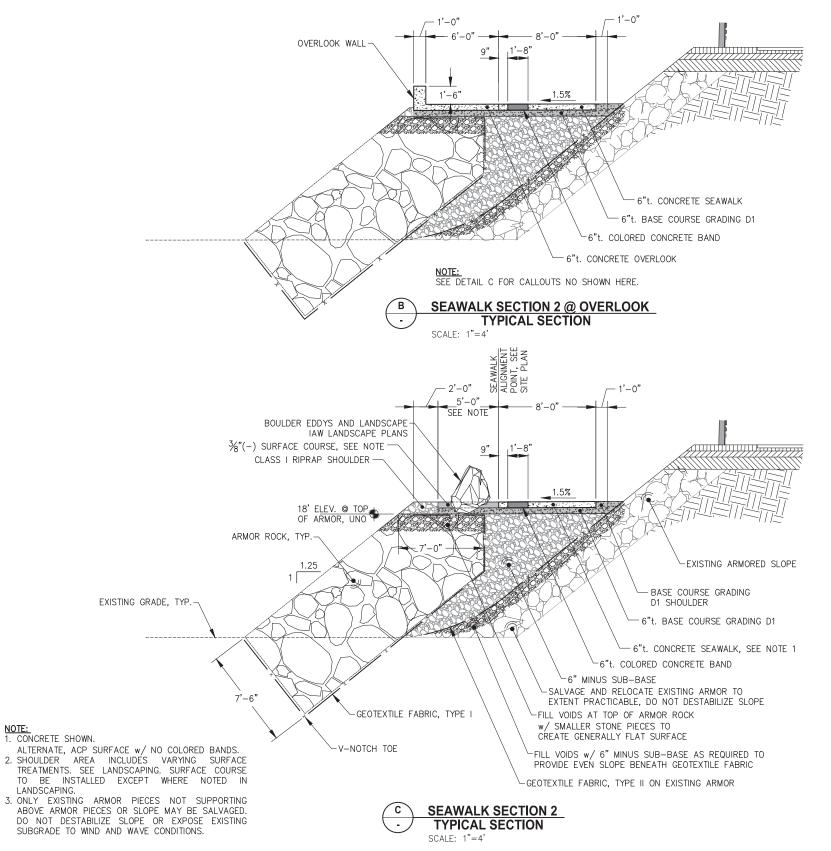

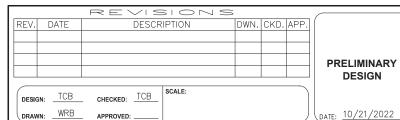


STATE OF ALASKA DEPARTMENT OF TRANSPORTATION AND PUBLIC FACILITIES SITKA SEAWALK PHASE II AKDOT&PF PROJECT NO. SFHWY00312


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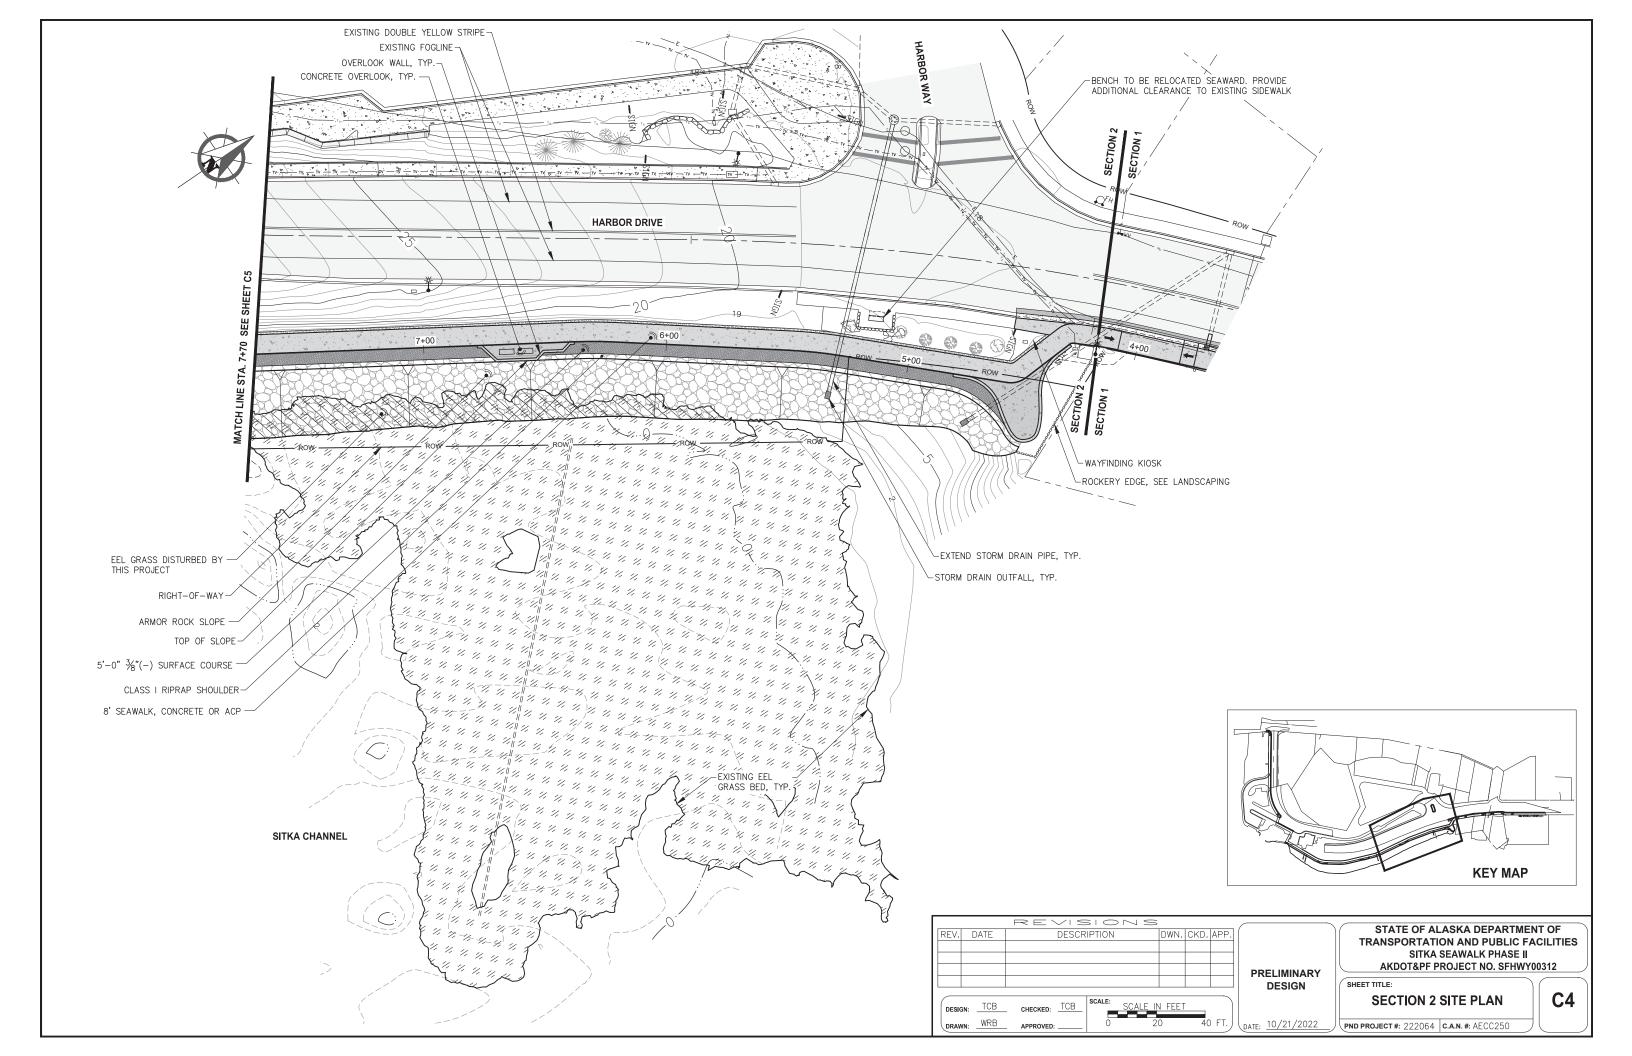
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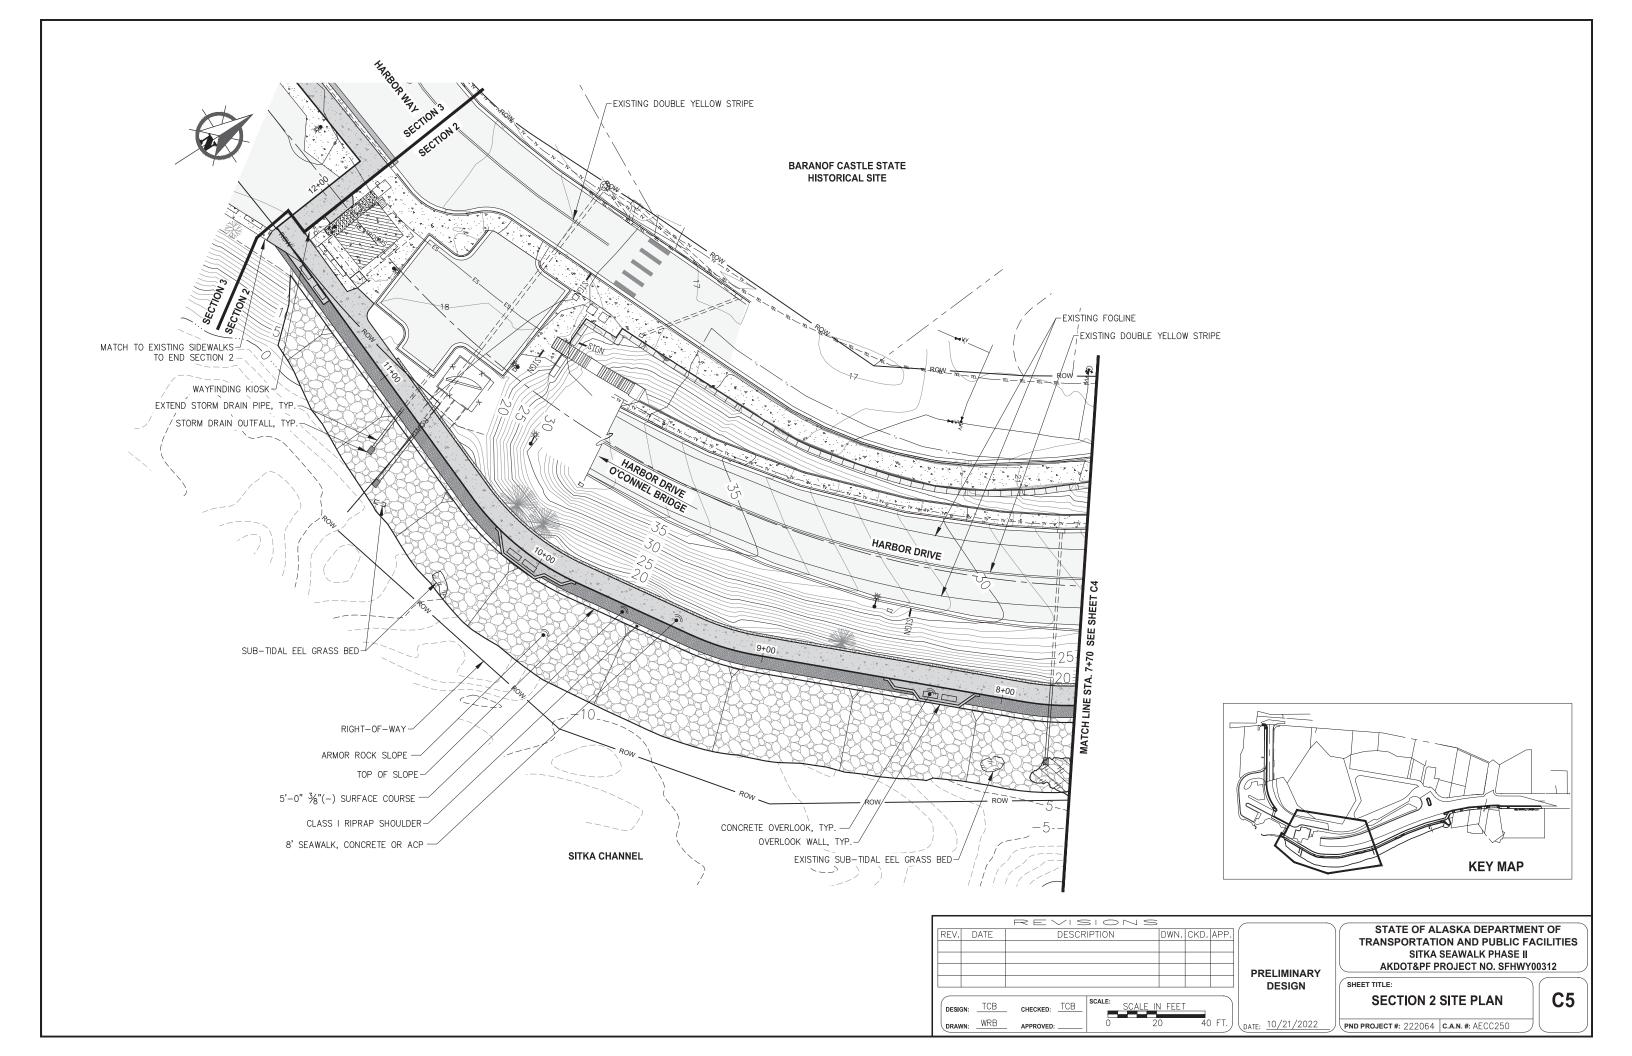
TYPICAL SECTIONS


PND PROJECT #: 222064 C.A.N. #: AECC250







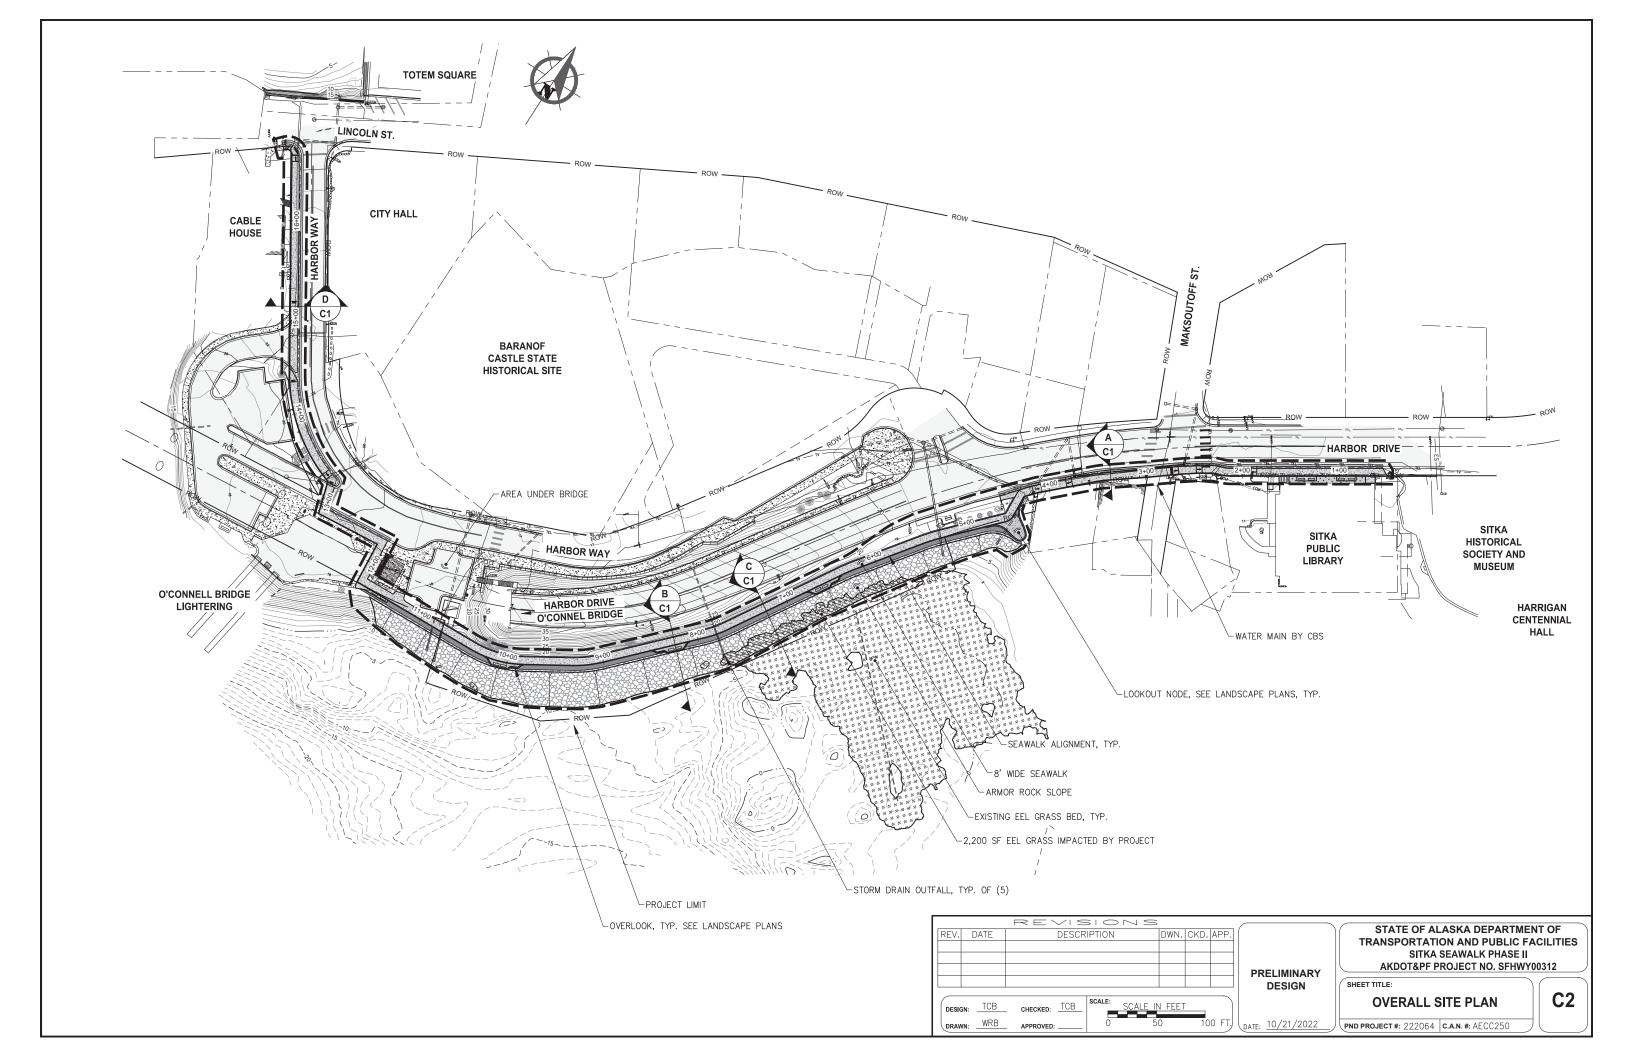


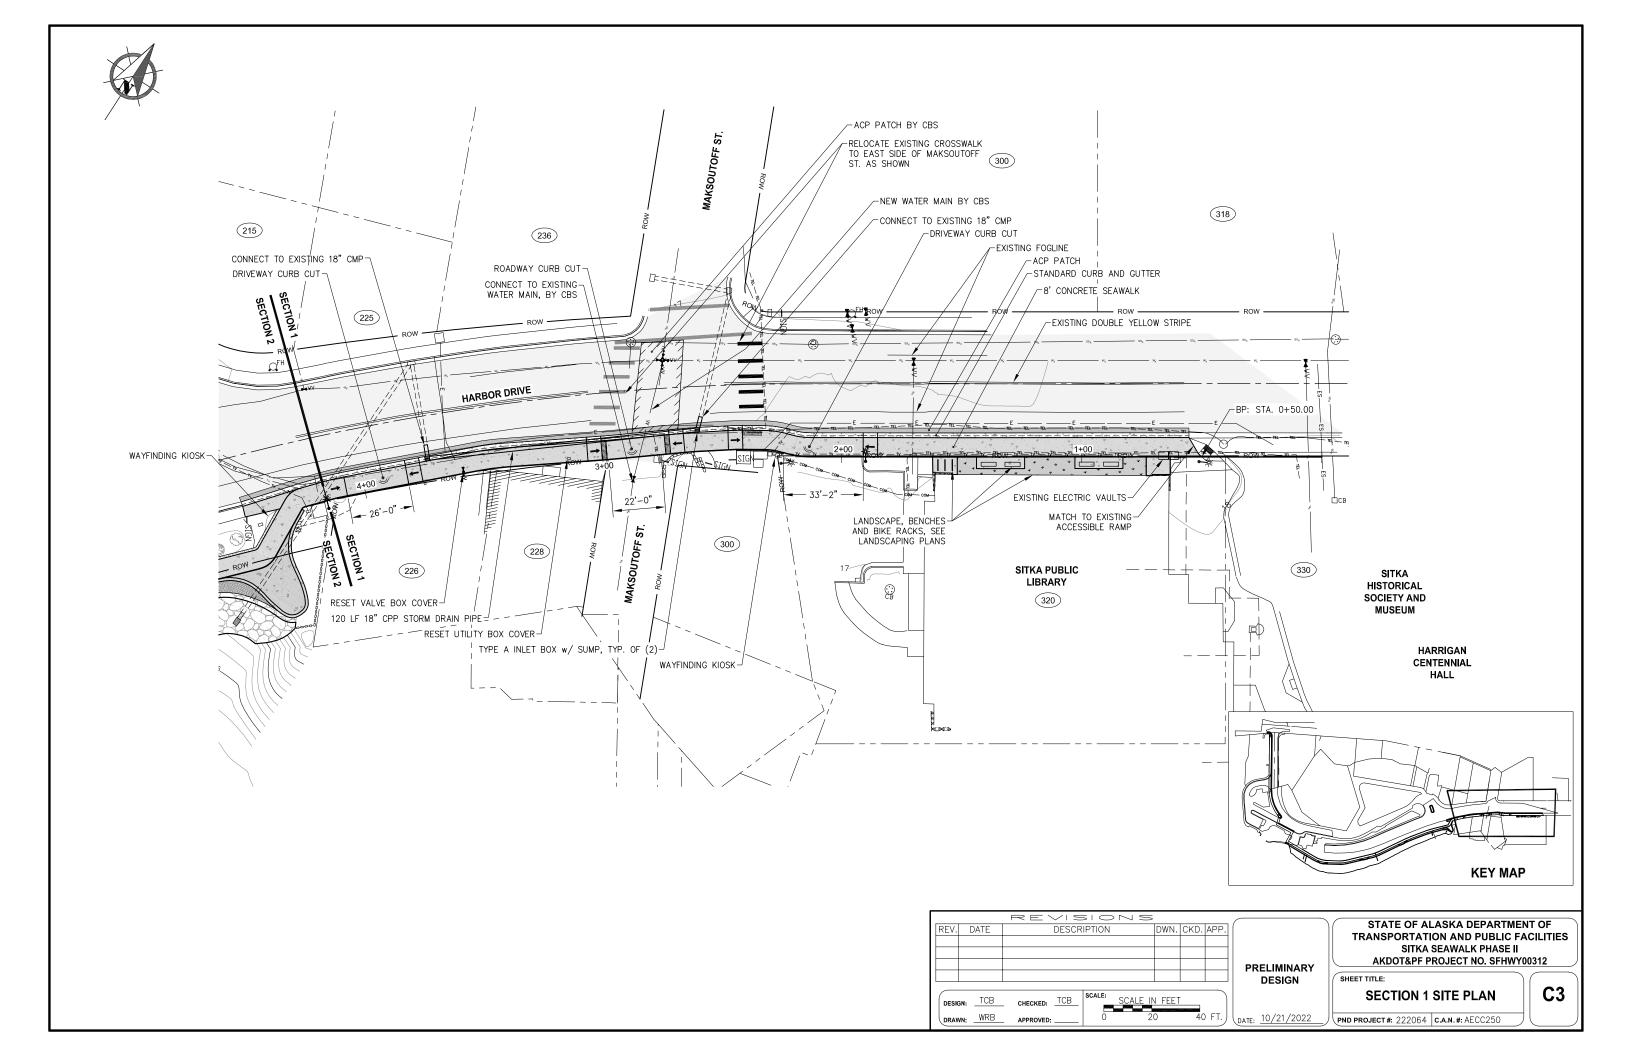


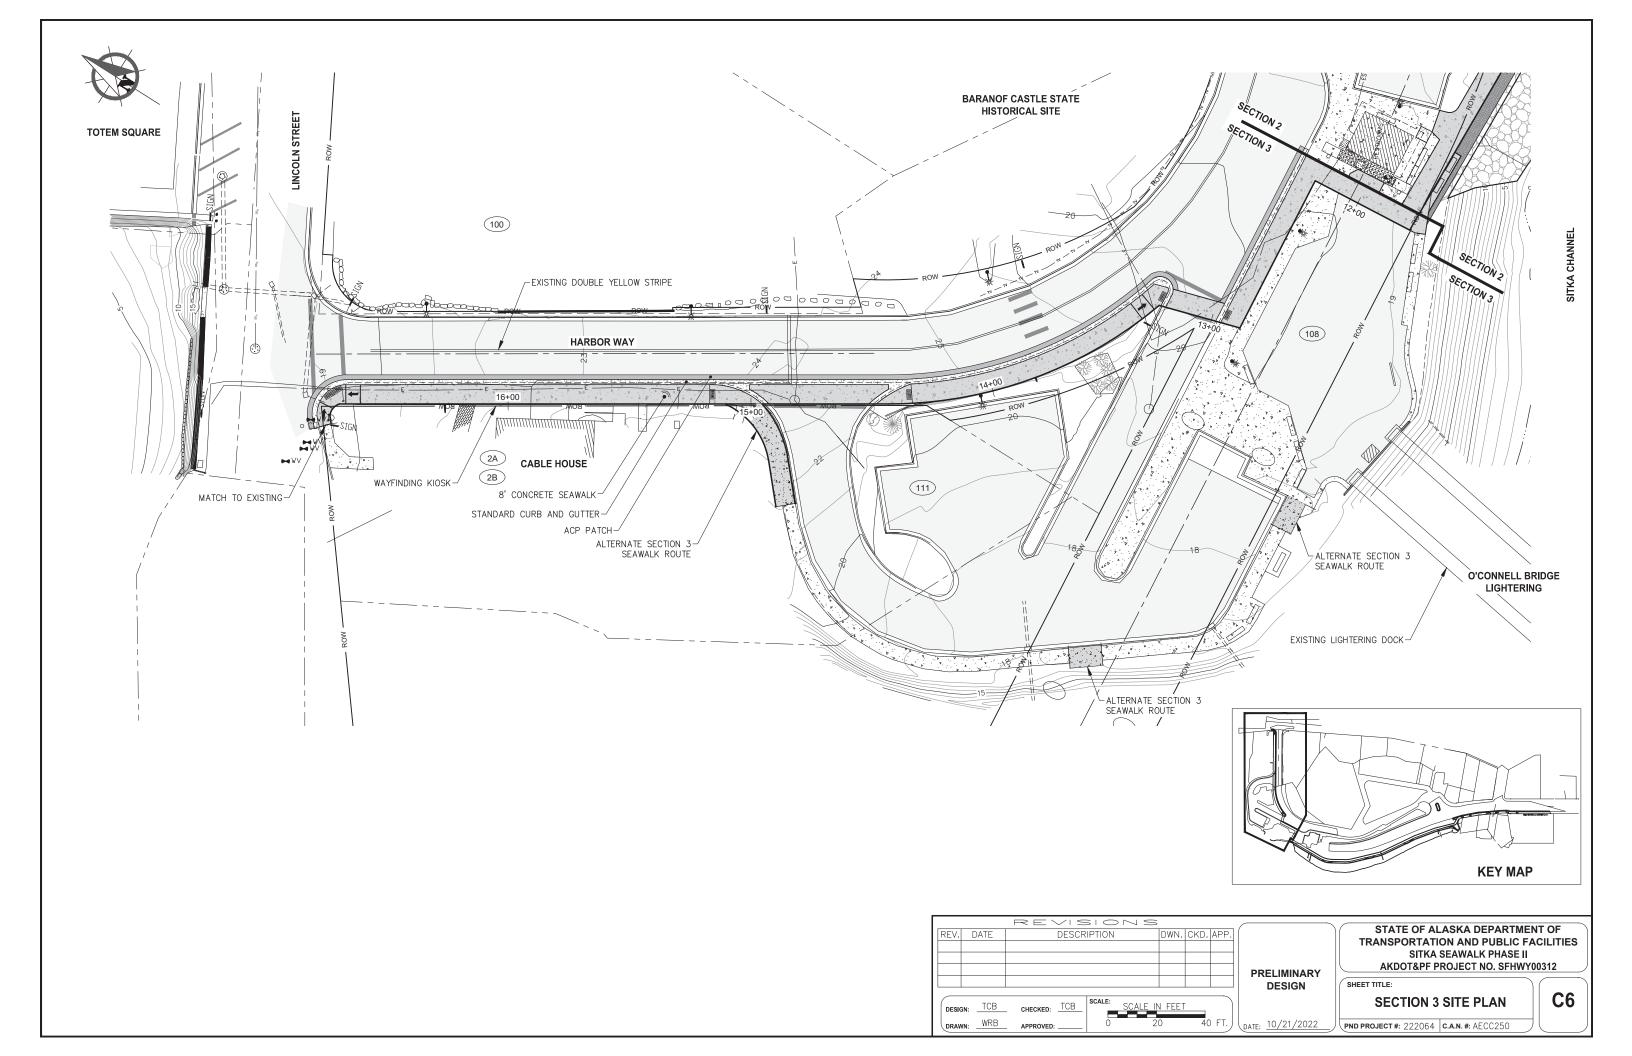


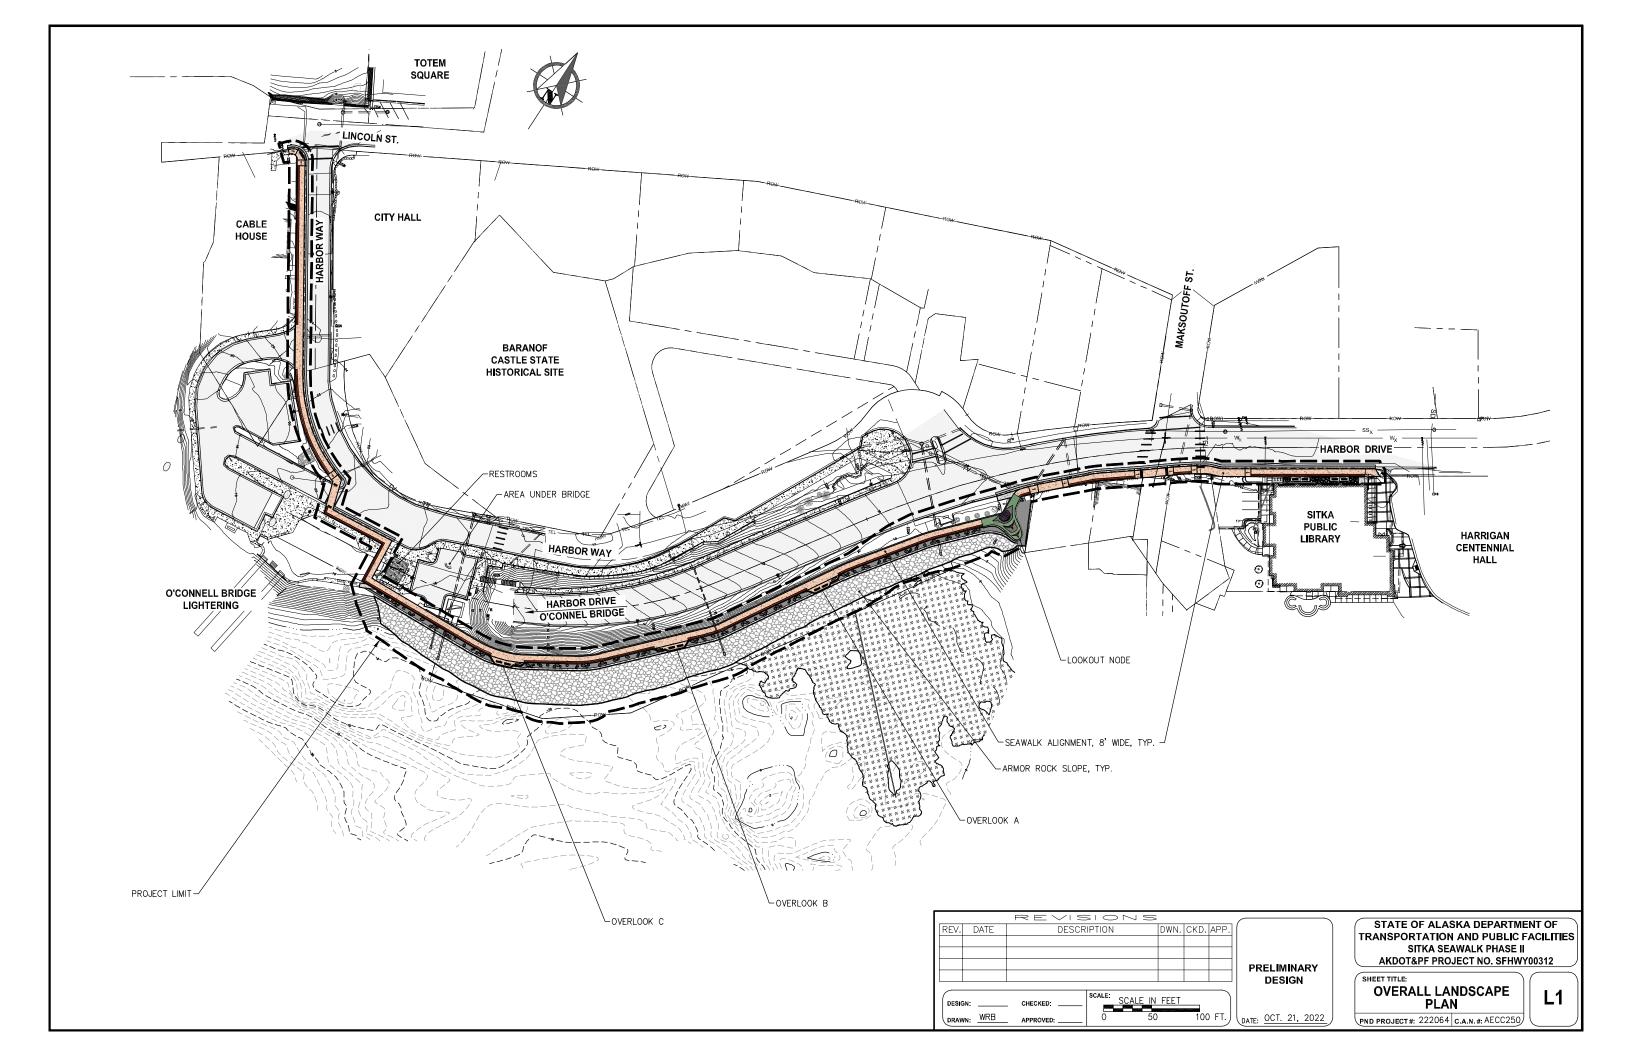


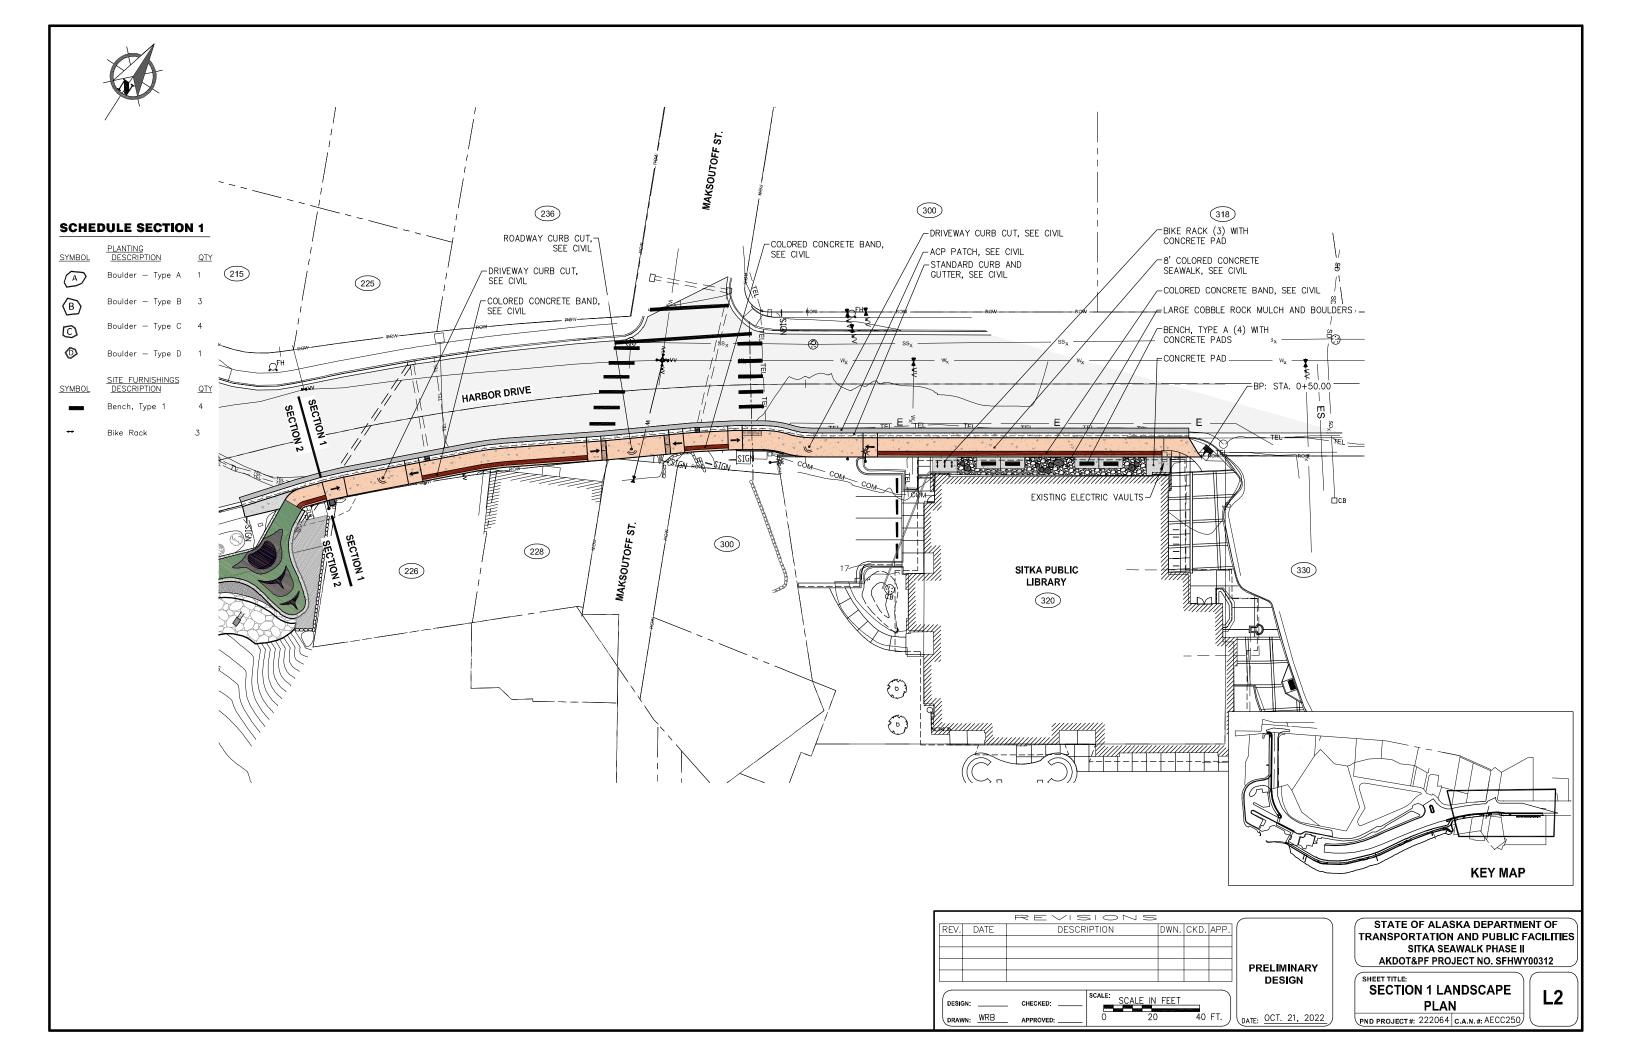

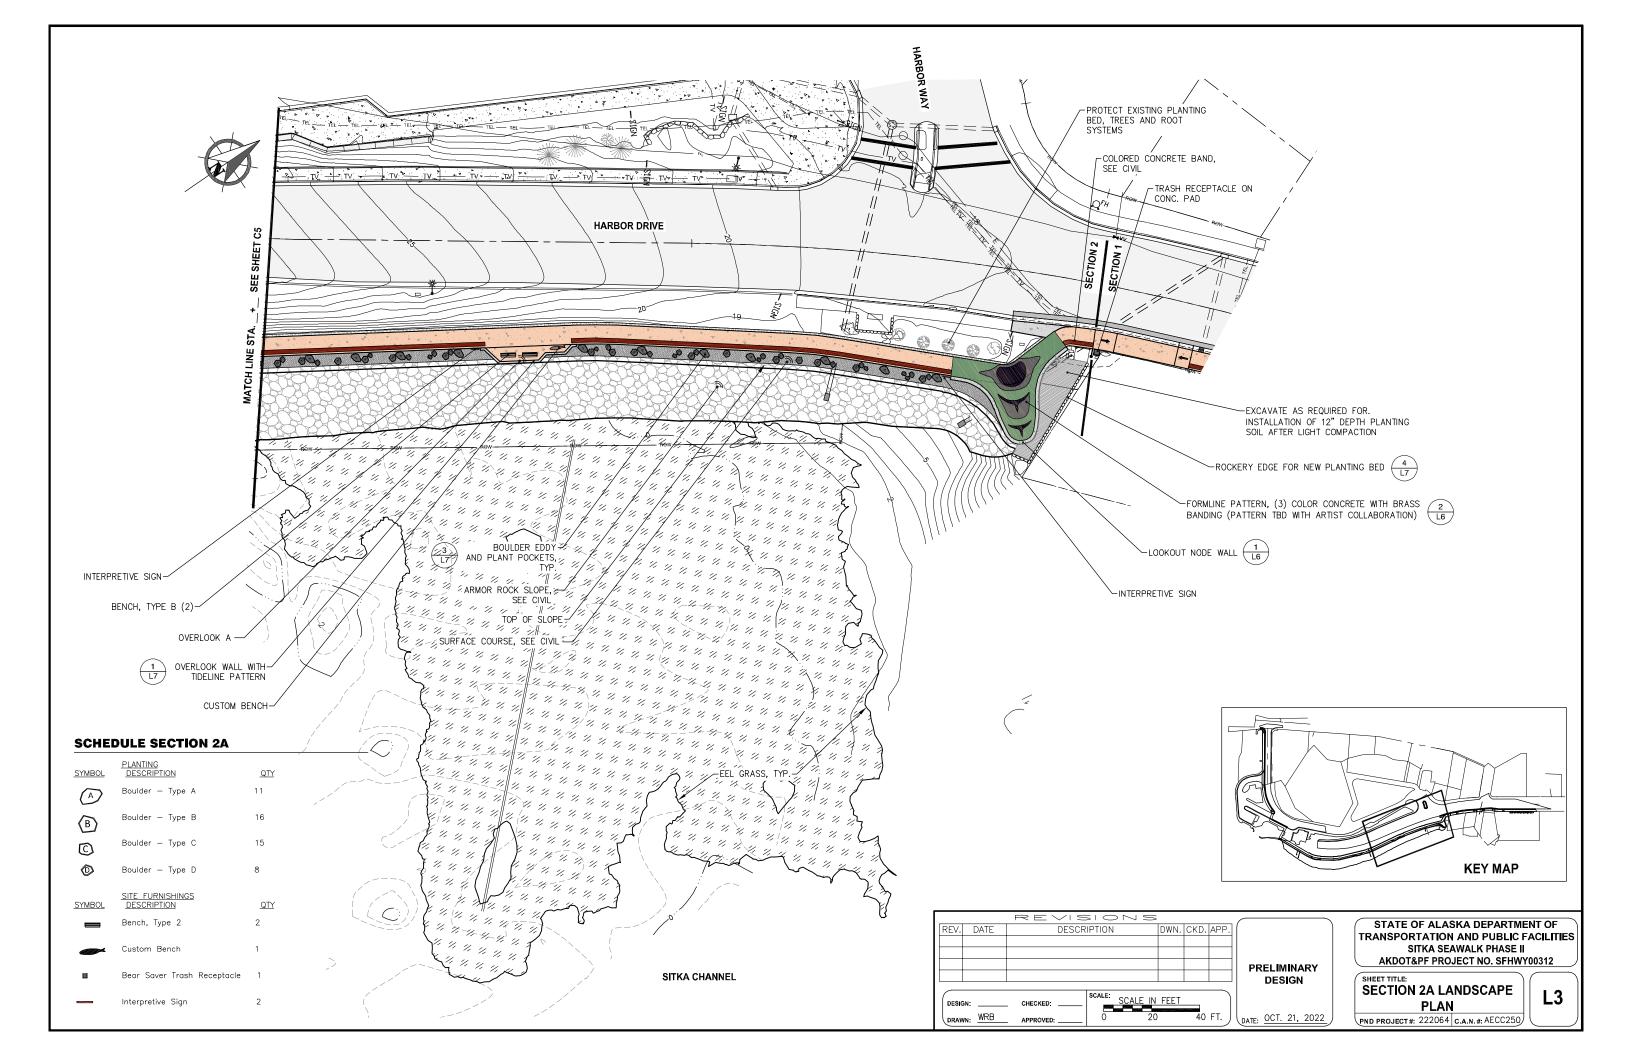

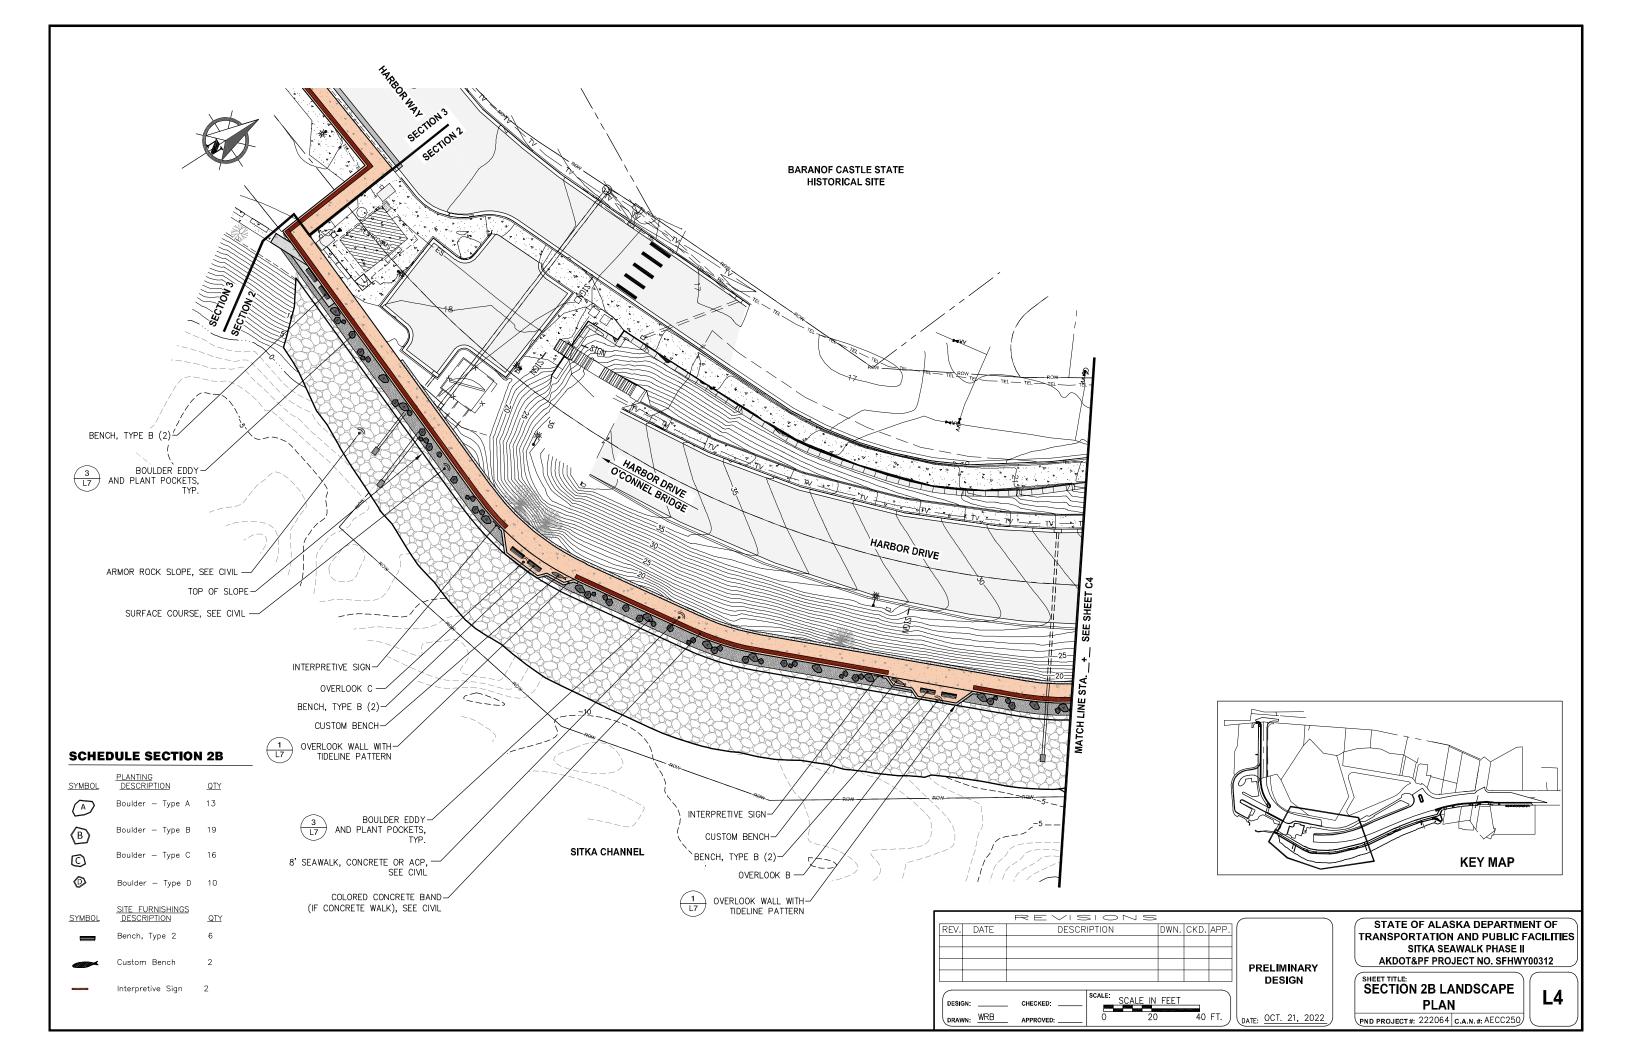

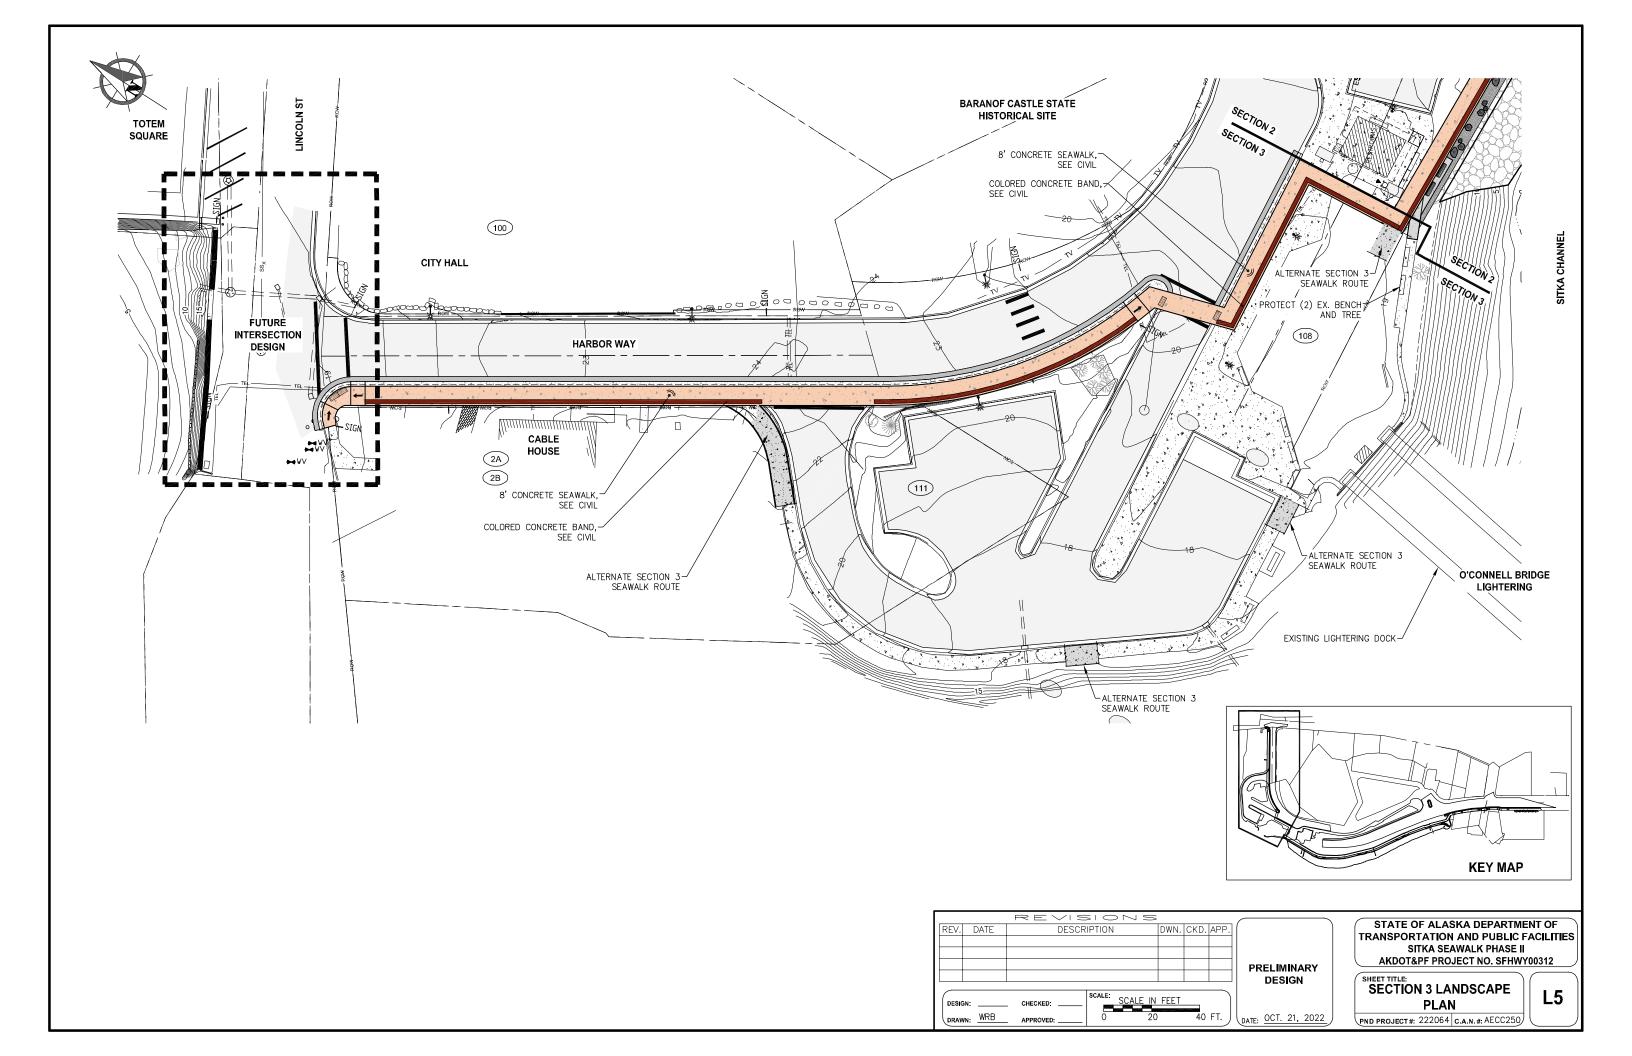

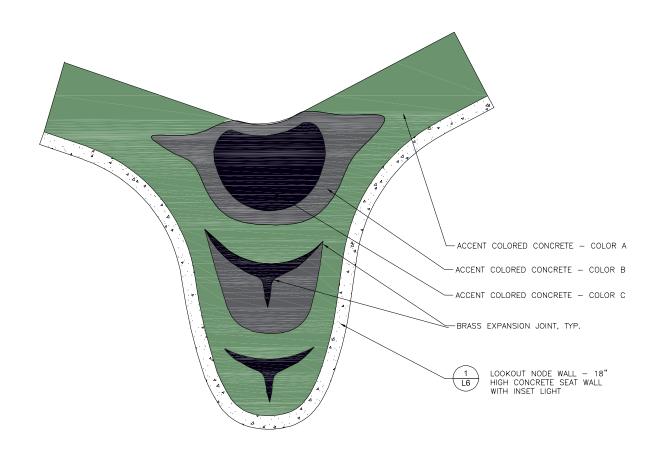


NOTES:
1. FORMLINE PATTERN IS A PLACEHOLDER PENDING ARTIST COLLABORATION

FORMLINE CONCRETE PATTERN - LOOKOUT NODE

3/16" = 1'-0"

S-PAVR-07

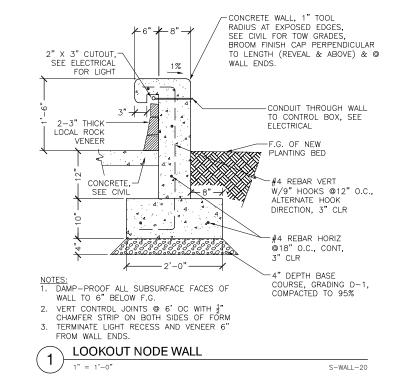

REV. DATE DESCRIPTION DWN. CKD. APP.

PRELIMINARY DESIGN

DESIGN: _____ CHECKED: _____ SCALE: SCALE IN FEET ______ 0 20 40 FT.

DRAWN: WRB APPROVED: _____ 0 20 40 FT.


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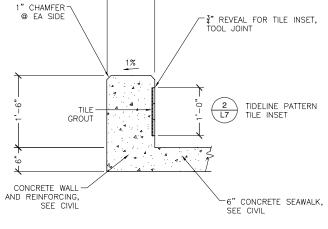
L6

SHEET TITLE

LANDSCAPE DETAILS

PND PROJECT#: 222064 C.A.N.#: AECC250



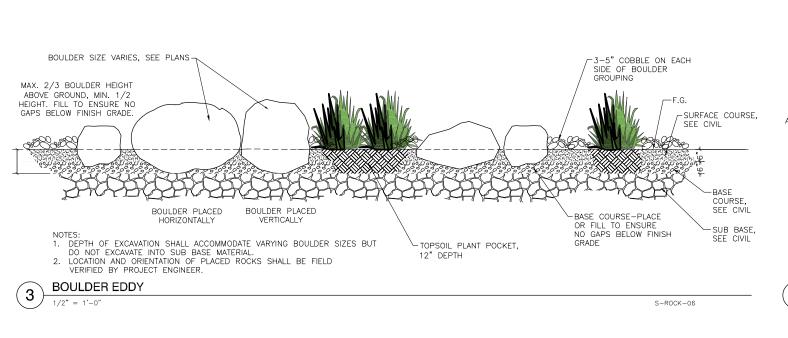

NOTES:
1. SEE CIVIL FOR TOW GRADES
2. BROOM FINISH CAP AND INSIDE FACE (ABOVE AND BELOW REVEAL) PERPENDICULAR TO LENGTH


/1'-0" /

- 3. SACK FINISH OUTSIDE FACE 4. DAMP-PROOF ALL SUBSURFACE FACES OF WALL
- TO 6" BELOW F.G. 5. VERT CONTROL JOINTS @ 6' OC WITH \frac{1}{2}" CHAMFER STRIP ON BOTH SIDES OF FORM


OVERLOOK WALL

EXCAVATE AS REQUIRED FOR 12" TOPSOIL DEPTH, CROWN 4:1 FROM -ROCKERY EDGE SHOT ROCK-NON-WOVEN-GEOTEXTILE FABRIC -KEY 2' BASE EXISTING APPROX 6" ROCK GRADE

ROCKERY EDGE 4 S-EDGE-09

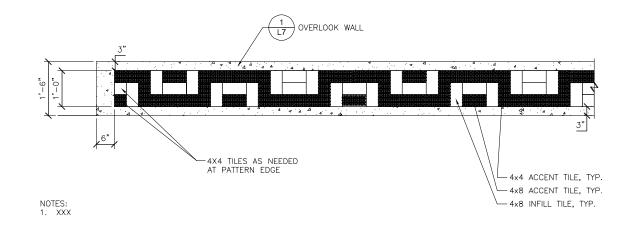

OVERLOOK WALL TIDELINE PATTERN S-WALL-19

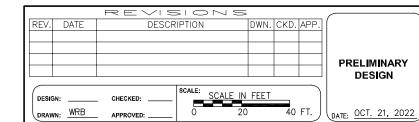



STATE OF ALASKA DEPARTMENT OF TRANSPORTATION AND PUBLIC FACILITIES SITKA SEAWALK PHASE II AKDOT&PF PROJECT NO. SFHWY00312

S-WALL-18

LANDSCAPE DETAILS

PND PROJECT#: 222064 C.A.N.#: AECC250

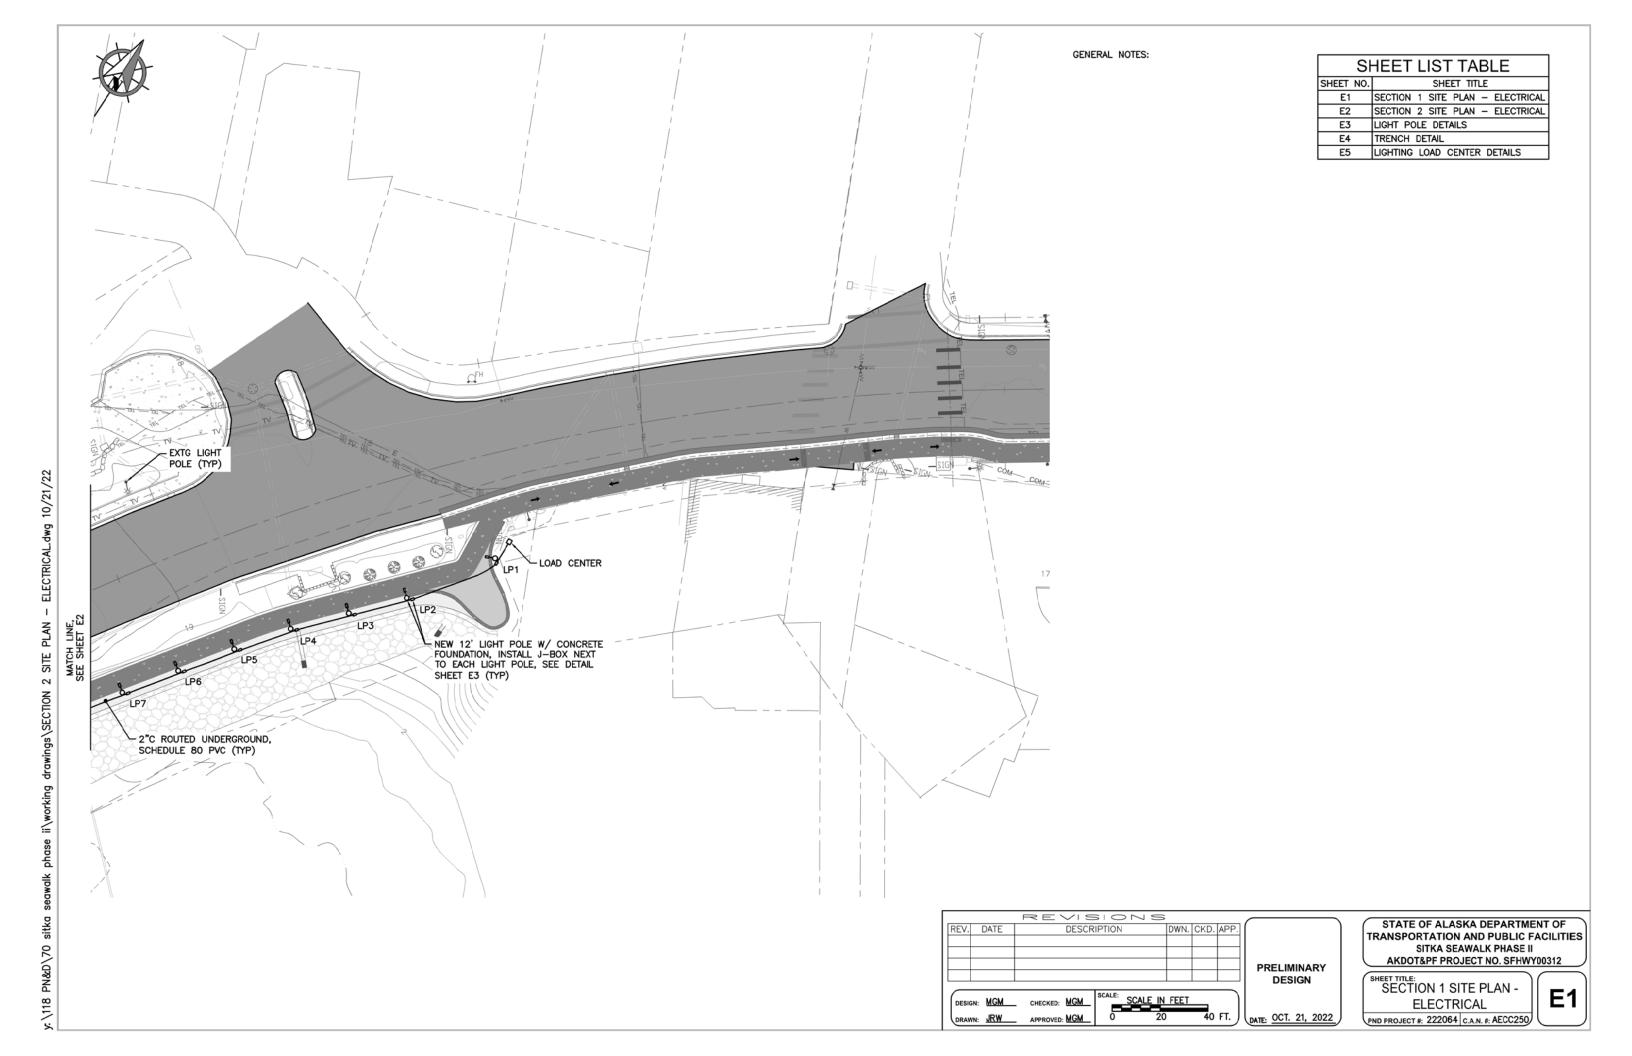


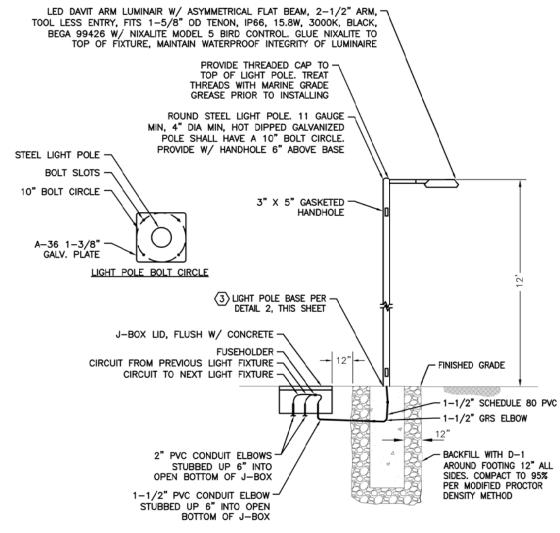


NOTES

- ALL SPLICES SHALL BE IN BASE OF LIGHT POLE. LOOP FEED POWER CONDUCTORS IF REQUIRED.
- 2. PROVIDE GROUNDING BUSHINGS ON CONDUIT.
- 4. SIZE LIGHT POLE WITH LUMINAIRES FOR 120 MPH SUSTAINED WINDS WITH GUSTS TO 150 MPH. LIGHT POLE DIMENSIONS SHOWN ARE A MINIMUM. PROVIDE CALCULATIONS SHOWING COMPLIANCE SEALED BY CIVIL ENGINEER REGISTERED IN ALASKA.



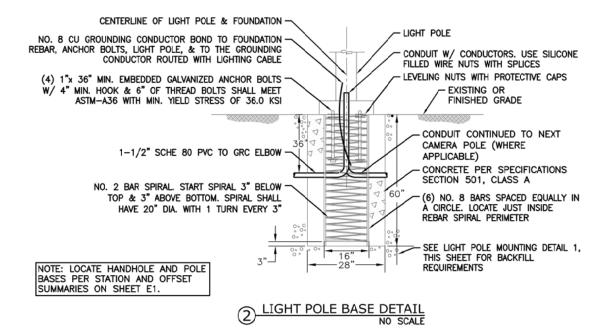

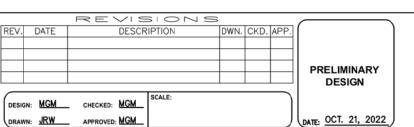


STATE OF ALASKA DEPARTMENT OF TRANSPORTATION AND PUBLIC FACILITIES SITKA SEAWALK PHASE II AKDOT&PF PROJECT NO. SFHWY00312

SHEET TITLE

LIGHT POLE DETAILS


PND PROJECT #: 222064 C.A.N. #: AECC250

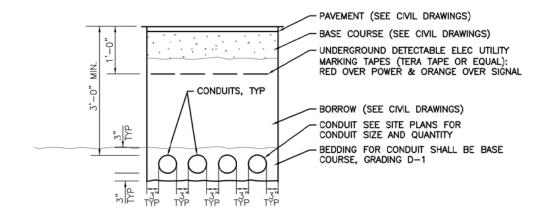

NOTES:

- 1. ALL DIMENSIONS ARE MINIMUM.
- SEE CIVIL DRAWINGS FOR TYPICAL SECTIONS UNDER PAVED AREAS. PROVIDE BACKFILL (MATERIAL, COMPACTION, ETC.) PER THE CIVIL DRAWINGS. WHERE NOT UNDER PAVEMENT, PROVIDE D1 IN THE TOP 12" WITH SELECT BORROW BELOW.
- 3. THE LOCATION OF ALL EXISTING PIPING, CONDUIT, ETC MAY NOT BE WHERE SHOWN AND MAY NOT BE SHOWN. ALL LOCATIONS THAT ARE SHOWN ARE APPROXIMATE AND SHOULD BE FIELD VERIFIED. OBTAIN UTILITY LOCATES PRIOR TO DIGGING. DIG WITH CAUTION. AVOID WATER, SEWER, DRAINAGE PIPES AND OTHER CONFLICTS.
- 4. MAINTAIN 12 INCHES MINIMUM SEPARATION (ALL DIRECTIONS) BETWEEN POWER AND OTHER CONDUITS, PIPES, ETC.
- 5. NOT USED.
- 6. SAWCUT AND REPLACE ASPHALT, CONCRETE, Z E CONCRETE CURB, GUTTER, SIDEWALKS, ETC. AS NECESSARY TO INSTALL CONDUIT AND OTHER ELECTRICAL ITEMS. SAWCUT ASPHALT BACK 18" ON EACH SIDE OF EDGE OF TRENCH OR EXCAVATION AREA (ALL SIDES). THERE SHALL BE 18" OF UNDISTURBED SOIL BETWEEN EDGE OF SAWCUT AND EXCAVATION LIMITS. ALL TRENCHES SHALL BE 18" WIDE MINIMUM. COMPACT BACKFILL TO 95%. COMPACT D-1 TO 100% WHERE COVERED WITH PAVEMENT. RE-PAVE SAWCUT AREAS PER PAVING SPECIFICATIONS.
- 8. MODIFY CONDUIT BURIAL DEPTH WHERE SHOWN ON DRAWINGS AND AS REQUIRED TO AVOID ALL OBSTACLES. ROUTE BELOW OBSTACLES.



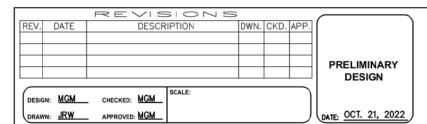

STATE OF ALASKA DEPARTMENT OF TRANSPORTATION AND PUBLIC FACILITIES SITKA SEAWALK PHASE II AKDOT&PF PROJECT NO. SFHWY00312

SHEET TITLE

TRENCH DETAIL

PND PROJECT #: 222064 C.A.N. #: AECC250

y: \118

125A, 5 JAW-

DOOR FOR METER-

CONTINUOUS HINGE -

& MAIN CIRCUIT

DEAD FRONT COVER. MOUNT HOA

SHEET. SKYLINE OR EQUAL.

SHALL BE STAINLESS STEEL.

DOOR FOR CIRCUIT BREAKER PANELS, ETC.

CONTINUOUS HINGE

1/4 TURN PAD LOCKABLE HANDLE

(TYPICAL)

PROVIDE FINISHED SURFACE TO FOUNDATION

LOAD CENTER STAINLESS STEEL

ENCLOSURE. ALL PARTS ON EXTERIOR

LOAD CENTER SHALL BE UL LISTED AS AN ASSEMBLY WITH FEATURES SHOWN ON THIS

FINISHED

GRADE


CONCRETE FOUNDATION. WIDTH AND LENGTH AS REQUIRED. PROVIDE 1/2" SMALLER THAN FOOTPRINT OF LOAD CENTER. PROVIDE DEPTH AS SHOWN. CONCRETE PER CIVIL

2" CONDUIT(S) TO


LIGHT POLES. MIN (3)

SWITCH & GFI REC IN COVER.


STAINLESS STEEL LOAD CENTER 120/240V, 1ø, 3W, 100A MOUNT ON CONCRETE BASE SEE DETAIL, THIS SHEET

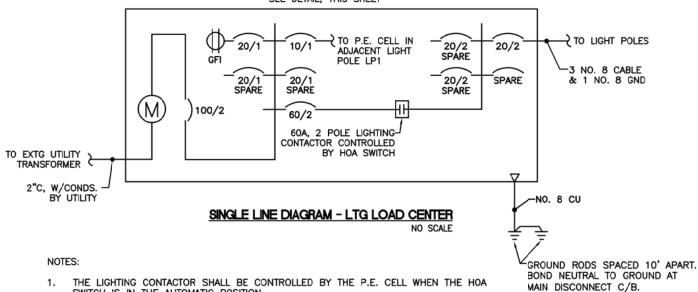

- SWITCH IS IN THE AUTOMATIC POSITION.
- INSTALL GROUNDING HUBS, THIRD PARTY CERTIFIED FOR WET LOCATIONS (MYERS TYPE), WHEN ATTACHING CONDUITS TO THE LOAD CENTER ENCLOSURE.
- LABEL ALL CIRCUIT BREAKERS AS TO FUNCTION AND POSITION. LABEL THE SELECTOR SWITCH "LIGHTING" AND ITS POSITIONS "ON-OFF-AUTO".
- STORE A SCHEMATIC DIAGRAM, A CIRCUIT DIRECTORY, AND A MATERIALS LIST THAT INCLUDES THE MANUFACTURER'S NAME AND PART/CATALOG NUMBERS, ALL LAMINATED IN PLASTIC, IN A METAL POCKET ATTACHED TO THE INSIDE OF THE LOAD CENTER. INSTALL THE POCKET ON THE LOAD CENTER DOOR AND PROVIDE DRAIN HOLES IN THE LOAD CENTER TO PREVENT WATER ACCUMULATION.

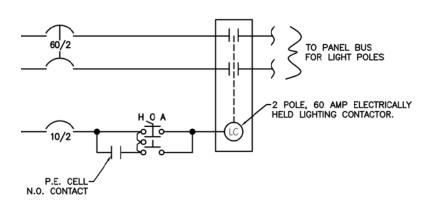

HOA SWITCH CONTROL SCHEMATIC

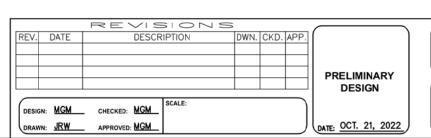

STATE OF ALASKA DEPARTMENT OF TRANSPORTATION AND PUBLIC FACILITIES SITKA SEAWALK PHASE II AKDOT&PF PROJECT NO. SFHWY00312

LIGHTING LOAD **CENTER DETAILS** PND PROJECT #: 222064 C.A.N. #: AECC250

E5